APPLICATION FOR PLANNING APPROVAL

Application Number: DA-2024-281

Proposal: Extension and alterations to dwelling

Subject Site: 2 Diamond Drive, Blackmans Bay

Responsible Planning Officer: Rianisa Fitriani

Advertised Documents:

Application Plans

Available upon request:

- Application Form
- Copy of Title

NOTE: The documents included for advertising (public notice) have been provided by the applicant. The advertising of the documentation does not confirm that Council agrees with, or endorses, the content or assessments.

Representations:


Representations must be provided in writing to Council stating the reasons why you support or object to the application. Representations for this application must be submitted by 11.59pm on **8 January 2025**; and can be delivered in person to the Civic Centre, posted to Locked Bag 1, Kingston 7050 or emailed to kc@kingborough.tas.gov.au.



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Plan Reference No: P1 Date Received: 23/08/2024

Date placed on Public Exhibition: 14/12/2024

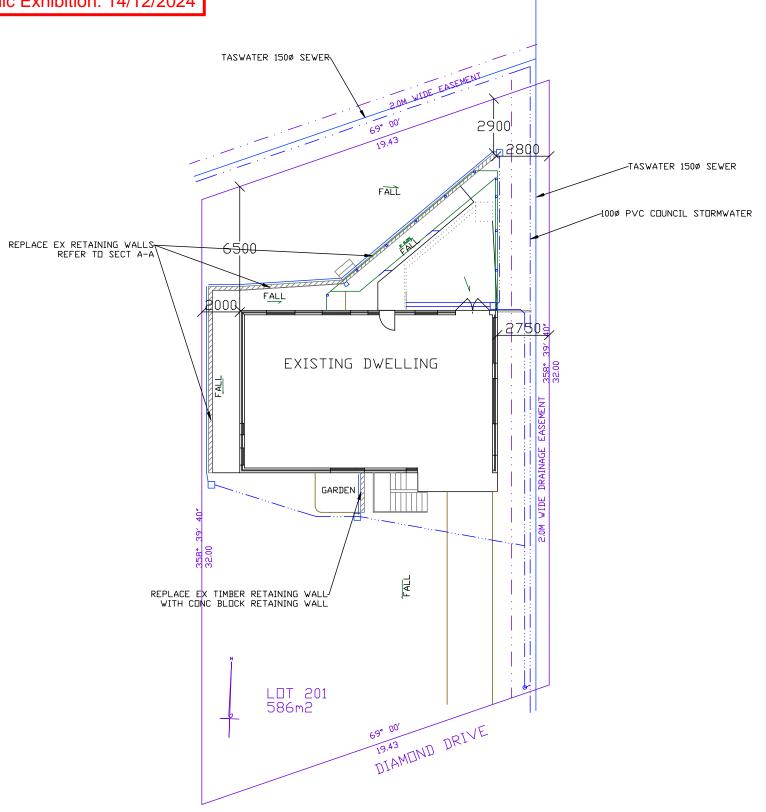

SCALE: 1:200
SHEET 1 OF 11
DWG MCC0123
13 NOVEMBER 2023
REVISION 1
DRAWN BY WILLBUILT
RTN CC1911 P
DECK & RETAINING
WALLS

P McCONVILLE
EE FITZGERALD
LOT201 No2
DIAMOND DRIVE
BLACKMANS BAY7053
V 5069 F 201




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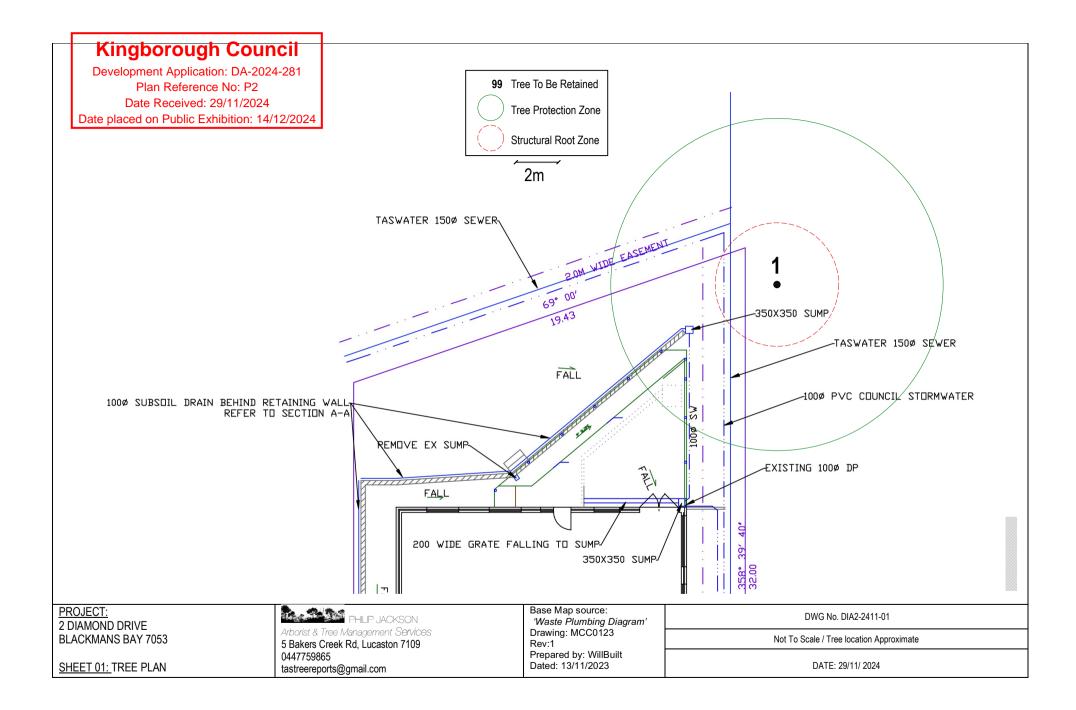
GENERAL NOTES
THESE DRAWINGS ARE TO BE READ
IN CONJUNCTION WITH THE BUILDING SPECIFICATIONS,
GEOTECHNICAL & STRUCTURAL ENGINEERING
SPECIFICATIONS & PLANS WHERE REQUIRED.
USE FIGURED DIMENSIONS ONLY. DO NOT SCALE THE
DRAWING

ALL WORK SHALL BE IN ACCORDANCE WITH THE BUILDING CODE OF AUSTRALIA (BCA) & RELEVANT STANDARDS.

THE BUILDER IS TO CHECK ALL SITE BOUNDARIES, SITE DIMENSIONS, DIMENSIONS OF ANY EXISTING BUILDING IN RELATIONSHIP TO THE PROPOSED WORKS LEVELS, BEARINGS, EXISTING SEWER & STORMWATER DRAINS & DUTLETS & THE LOCATION OF ANY EASEMENT BOUNDARIES PRIOR TO THE COMMENCEMENT OF ANY WORKS.

FLOOR AREA DWELLING 121m2 FLOOR AREA DECK 41.5m2 INCLUDING RAMP

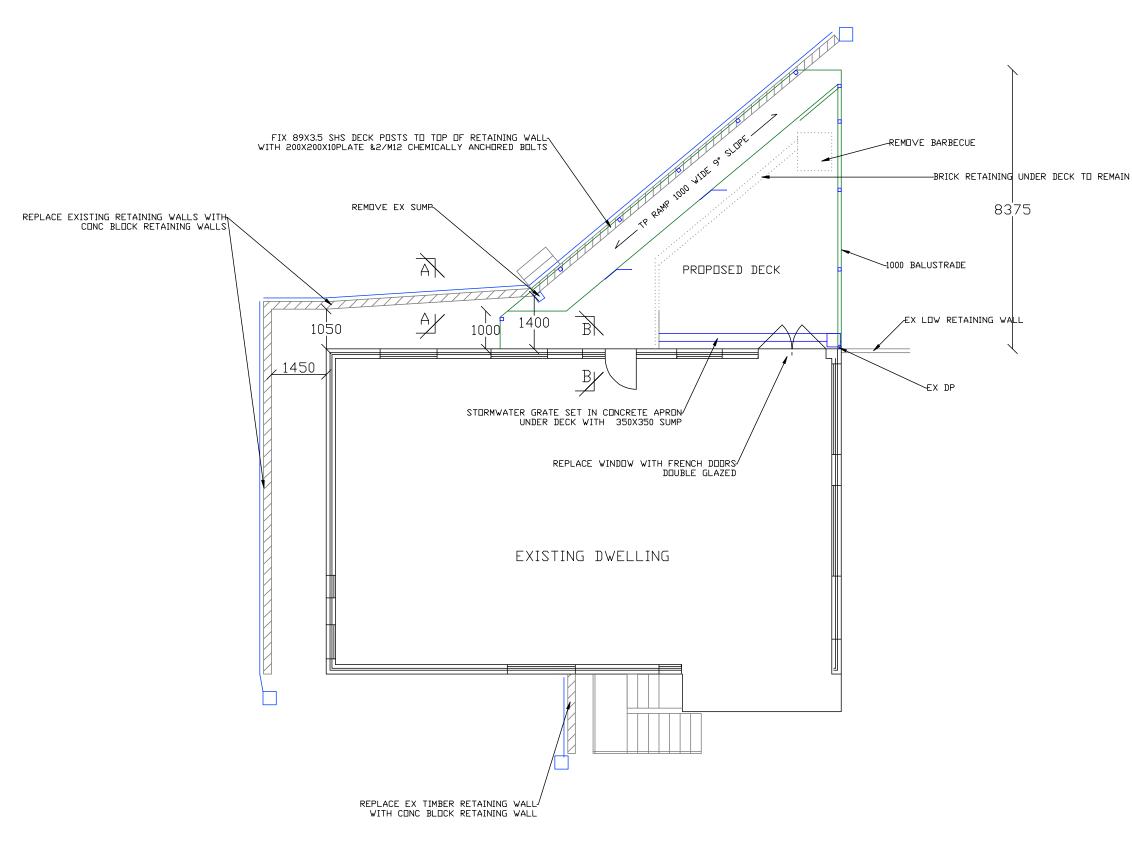



Identifier	Euc species	Age Class	Height (m)	Spread (m)	DBH (m)	DAB(m)	Overall Vitality	Overall Structure	Life expectancy	Conservation Value	TPZ(m)	SRZ(m)	TPZ/SRZ Encroachment	Likely Impact	Recommendation	Comments
														Acceptable level of		
	Brittle Gum													encroachment.		
1	(Eucalyptus mannifera)	М	16-20m	20	0.65	0.72	G	G	L	n/a	7.8	2.9	3%	Minimal impact	Rt	Tree in neighbouring property

NOTES

Identifier: Unique identifier of subject trees.

Age Class: Y = young, SM = semi-mature, EM = early-mature, M = mature, PM = post-mature (senescent)

Height Class: 0-5m; 6-10m; 11-15m; 16-20m; 21-25m; >25m

DBH: Diameter at Breast Height (approximate)

DAB: Diameter above basal flare

Overall Vitality: G= Good; M=Moderate; P=Poor; Mo= Moribund; D= Dead

Overall Structure: G = Good; F = Fair; P = Poor; D= Dead.

Conservation Value: VH= Very High; H= High;

TPZ: Tree Protection Zone **SRZ:** Structural Root Zone

Life Expectancy: L= Long (>40 years); M= Medium (15-40 years); S= Short (5-15 years); T= Transient (< 5 years)

Recommendations: Rm= Remove, Rt= Retain

Kingborough Council


Development Application: DA-2024-281
Plan Reference No: P2
Date Received: 29/11/2024
Date placed on Public Exhibition: 14/12/2024

Document Set ID: 4549494 - Arborist & Tree Management Services Version: 1, Version Date: 11/12/2024

Development Application: DA-2024-281
Plan Reference No: P1

Date Received: 23/08/2024

Date placed on Public Exhibition: 14/12/2024

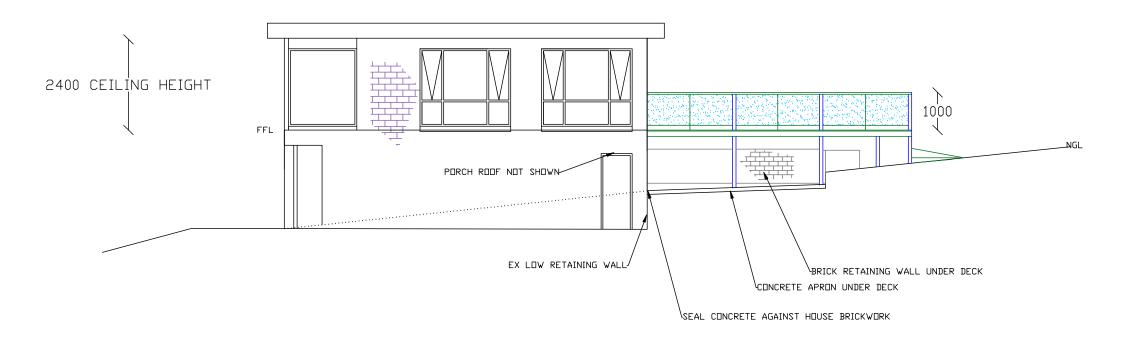

ALL GLAZING TO AS 1288
WINDOWS TO COMPLY WITH AS 2047-1999
TIMBER FRAMING TO AS 1684

EAST ELEVATION

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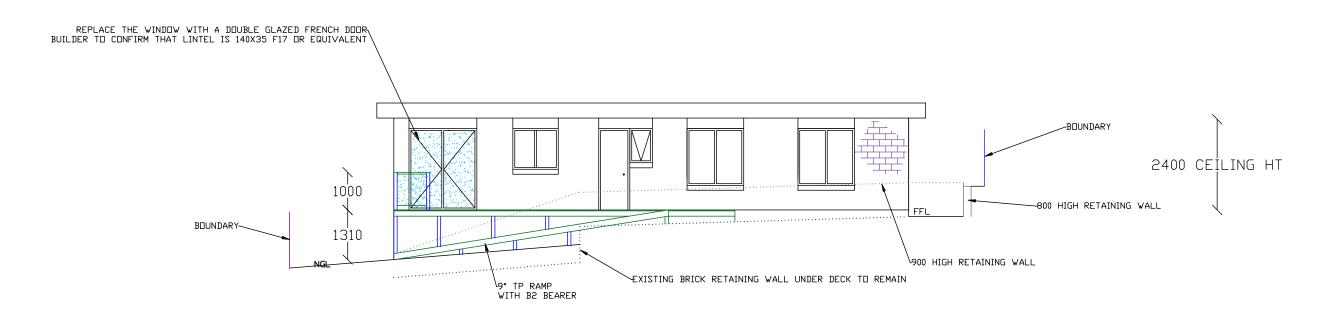
P McCONVILLE EE FITZGERALD LOT201 No2 DIAMOND DRIVE BLACKMANS BAY7053 V 5069 F 201



UPVC FRAMED FRENCH DOOR TO AS 2047 & AS 1288 DOUBLE GLAZED 4mm MIN GRADE A SAFETY GLASS. ALLOW FOR HUMAN IMPACT AS PER NCC PART 3.6.4 MARKED WITH AN OPAQUE BAND

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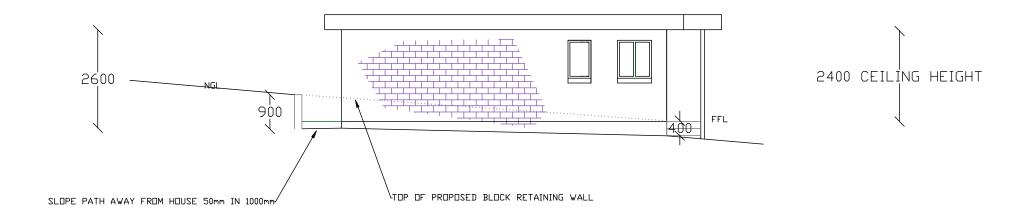
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NORTH ELEVATION



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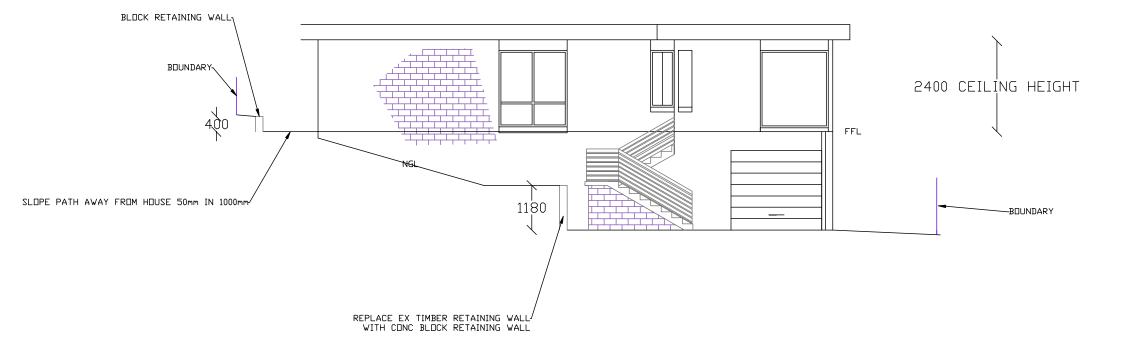
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- 1. ALL MASONRY TO CONFORM TO AS 3700 & BCA REQUIREMENTS

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 2. MASDNRY LINTELS TO ENGINEERS SPECIFICATION
 3. PROVIDE BRICK TIES AT MIN 600mm VERTICAL & HORIZONTAL CENTRES
 4. PROVIDE ARTICULATION JOINTS AT 6000mm MAX CENTRES
 5. PROVIDE DAMP PROOF COURSE ARDUND ALL WINDOWS & FLOOR LEVEL.
 6. PROVIDE WEEP HOLES BETWEEN EACH ALTERNATE BRICK & CLEAN ALL MORTAR FROM THE 25mm MIN WIDTH CAVITIES.
 7. RETAINING WALLS TO BE CONSTRUCTED AS PER ENGINEER APPROVED DRAWINGS
 9. DRC 15mm ABOVE CONCRETED APPAS

- 8. DPC 15mm ABOVE CONCRETED AREAS 9. MORTAR TO BE MIN ONE PART CEMENT TO 5 PARTS SAND
- 10. FACE JOINTS NEATLY FINISHED WITH STEEL ROD JOINTING TOOL



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SOUTH ELEVATION

SCALE: 1:100 SHEET 6 OF 11 **DWG MCC0123 13 NOVEMBER 2023 REVISION 1** DRAWN BY WILLBUILT RTN CC1911 P DECK & RETAINING WALLS


McCONVILLE EE FITZGERALD LOT201 No2 DIAMOND DRIVE BLACKMANS BAY7053 V 5069 F 201



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SCALE: 1:20
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RETAINING WALL CONSTRUCTION NOTES

- 1. MORTAR SHALL BE CEMENT : LIME: SAND RATIO 1 : 0-0.25 : 3
- 2. BLOCKS TO BE GRADE 12 TO AS 2733 $\,$
- 3. GRDUT MAXIMUM AGGREGATE SIZE 10mm- SLUMP 230+/- 30-MIN. CHARACTERISTIC STRENGTH 20 MPa
- 40 CLEAN OUT HOLES ARE TO BE PROVIDED TO THE BASE OF ALL CORES. AT THE END OF EACH DAYS BLOCK LAYING & BEFORE THE WALL IS FILLED , MORTAR DROPPINGS ARE TO BE WASHED OUT. REINFORCEMENT TIED & HOLES BLOCKED OFF
- 5. RETAINING WALL FOOTINGS ARE TO BE FOUNDED ON APPROVED TRIMMED SUBGRADE WITH A MINIMUM BEARING CAPACITY OF 150 kPa
- 6. CONCRETE STRENGTH (MPa)/ SLUMP(mm) FOOTINGS 25 / 90
- 7. 50mm COVER TO FOOTING BASE REINFORCEMENT
- 8. ALL CORES SHALL BE GROUT FILLED TO ONE COURSE ABOVE FINISHED SURFACE LEVEL
- 9. ALLOW MINIMUM 14 DAYS AFTER FILLING BLOCKS PRIOR TO BACKFILLING BEHIND WALL
- 10. CORE FILL SHALL BE PLACED WITH A PENCIL VIBRATOR
- 11. MDIST CURE WALL CONCRETE FOR 14 DAYS PRIOR TO WATERPROOFING
- 12. BACK OF WALL TO BE COATED WITH MINIMUM 2 COATS OF AN APPROVED BITUMINOUS PAINT LINED ITH FORTECON PROTECTED BY CORFLUTE OR SIMILAR SACRIFICIAL SHEETING
- 13. PROVIDE EXPANSION JOINTS AT MAX 10M CENTRES PROVIDE R16
 DOWEL BARS ACROSS JOINTS AT 400 CENTRES, GREASED AND
 CAPPED ONE END
- 14. WHERE WALL IS NOT RETAINING BLOCK WALLS SHALL BE CONSTRUCTED IN ACCORDANCE WITH 'BESSERs' SINGLE SKIN BLOCKWORK SYSTEM WITH BOND BEAM AND LINTELS AS REQUIRED

NDTE:

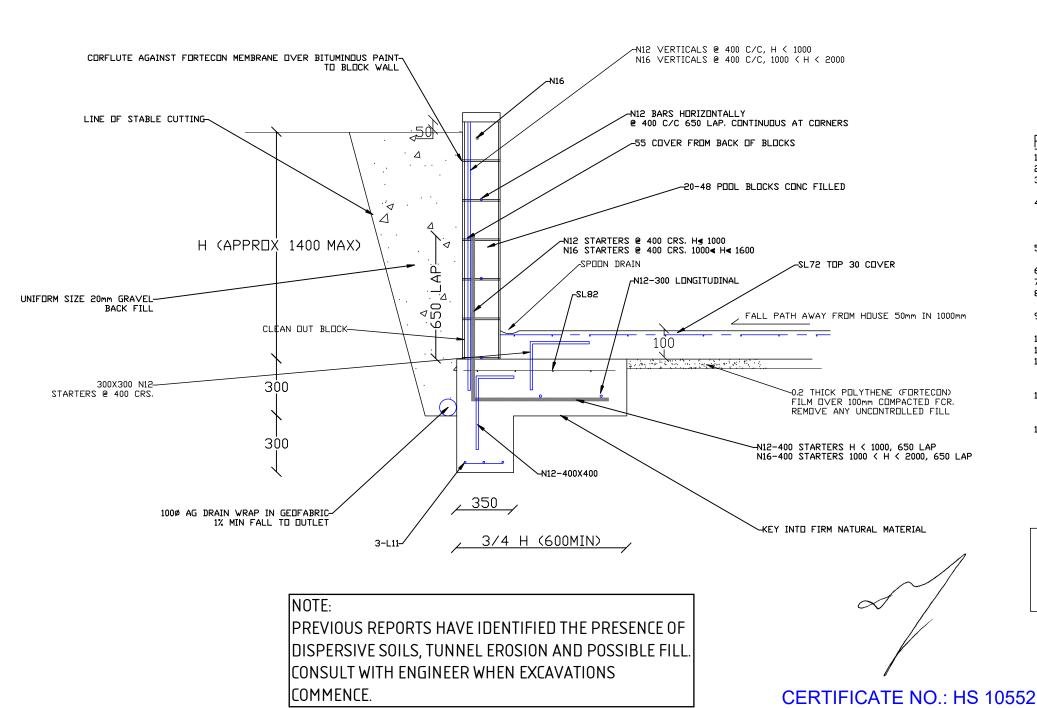ANY TREES THAT ARE WITHIN CLOSE PROXIMITY OF THE PROPOSED STRUCTURE SHOULD BE REMOVED

2/5/2024

WILLBUILT CC1911P T WILLIAMS 9 EUMATALLA ST LAUDERDALE Ph0418122582



RETAINING WALL DETAIL SECTION A-A

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Date placed on Public Exhibition: 14/12/2024 104**5**3 FALL ()C1 TOE OF RETAINING WALL C1 EX BRICK WALL 900 HIGH RETAINING WALL C1 ___C1 (°)C1 C1 2/N12 1000 LONG @ 100 CRS~ ALL 100 RC PATH AWAY FROM HOUSE 50mm IN 1000mm TO SPOUN DRAIN AND STORMWATER
SL72 TOP 30 COVER
SEAL JOINT WHERE CONCRETE MEETS BRICKWORK
WITH 10mm FOAM (EG. ABELFLEX) AND SEALANT (EG. SIKAFLEX) 9850

2100

1100 RETAINING WALL REFER TO SECTION A-A

FOOTING TOE TO RET WALL

FOUNDATION

SCALE: 1:100 SHEET 8 OF 11 DWG MCC0123 **13 NOVEMBER 2023 REVISION 1** DRAWN BY WILLBUILT RTN CC1911 P DECK & RETAINING WALLS

McCONVILLE EE FITZGERALD LOT201 No2 DIAMOND DRIVE BLACKMANS BAY7053 V 5069 F 201

C1 - 89X3.5 SHS DURAGAL COLUMN WELDED TO 180X180X10 PLATE WITH 4/N12 CRANKED ANCHOR BARS 400 DA EMBEDDED IN 450 DIA CONC PIER MIN 600 DEEP TO ROCK SHAPE TOP OF PIER TO PREVENT PONDING C2 - 89X3.5 SHS DURAGAL COLUMN WELDED TO 180X180X10 PLATE WITH 4/M12 BOLTS CHEMICALLY ANCHORED TO THE RETAINING

STRUCTURAL STEEL NOTES

WALL- 80mm EMBEDMENT

- 1. ALL EXPOSED STEELWORK SHALL BE HOT DIPPED GALVANISED OR PAINTED WITH AN APPROVED CORROSION RESISTANT PAINT SYSTEM TO A.B.C.B HOUSING PROVISIONS, SECTION 6.3.9 REQUIREMENTS FOR CATEGORY LOW ENVIRONMENTS
- 2. STRUCTURAL STEELWORK SHALL COMPLY WITH AS4100
- 3. ALL WELDS SHALL BE 6mm C.F.W. U.N.D.

FOOTING NOTES:

LINE OF EXISTING CONC APRON

- 1. ALL FOOTING CONSTRUCTION SHALL COMPLY WITH AS2870 2. ENGINEER SHALL INSPECT FOOTINGS PRIOR TO POURING OF CONCRETE
- 3. GROUND TO BE SHAPED TO FALL AWAY FROM THE BUILDING 50mm
- DVER 1000mm IN ACCORDANCE WITH BCA REQUIREMENTS
- 4. CONCRETE SHALL BE fc 25MPa U.N.O.
- 5. COVER 30mm TOP 45mm SIDES & BOT U.N.O.
- 6. ALL CONCRETE SHALL BE PLACED WITH A MECHANICAL VIBRATOR MOIST CURE ALL SLABS MIN 7 DAYS
- 7. CONCRETE TO COMPLY WITH BCA PART 4.2.10 8. REMOVE EXCESS SPOIL FROM THE SITE

CERTIFICATE NO.: HS 10552 2/5/2024


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400 HIGH RETAINING WALL-

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SCALE: 1:50 & 1:10 SHEET 9 OF 11 DWG MCC0123 **13 NOVEMBER 2023 REVISION 1** DRAWN BY WILLBUILT RTN CC1911 P DECK & RETAINING

McCONVILLE EE FITZGERALD LOT201 No2 DIAMOND DRIVE BLACKMANS BAY7053 V 5069 F 201

ANCHOR BARS 400 DA EMBEDDED IN 450 DIA CONC PIER MIN 600 C2 - 89X3.5 SHS DURAGAL COLUMN WELDED TO 180X180X10 PLATE WITH 4/M12 BOLTS CHEMICALLY ANCHORED TO THE RETAINING

LED - 140X45 F7 H3 LEDGER REFER TO DETAIL FOR FIXING

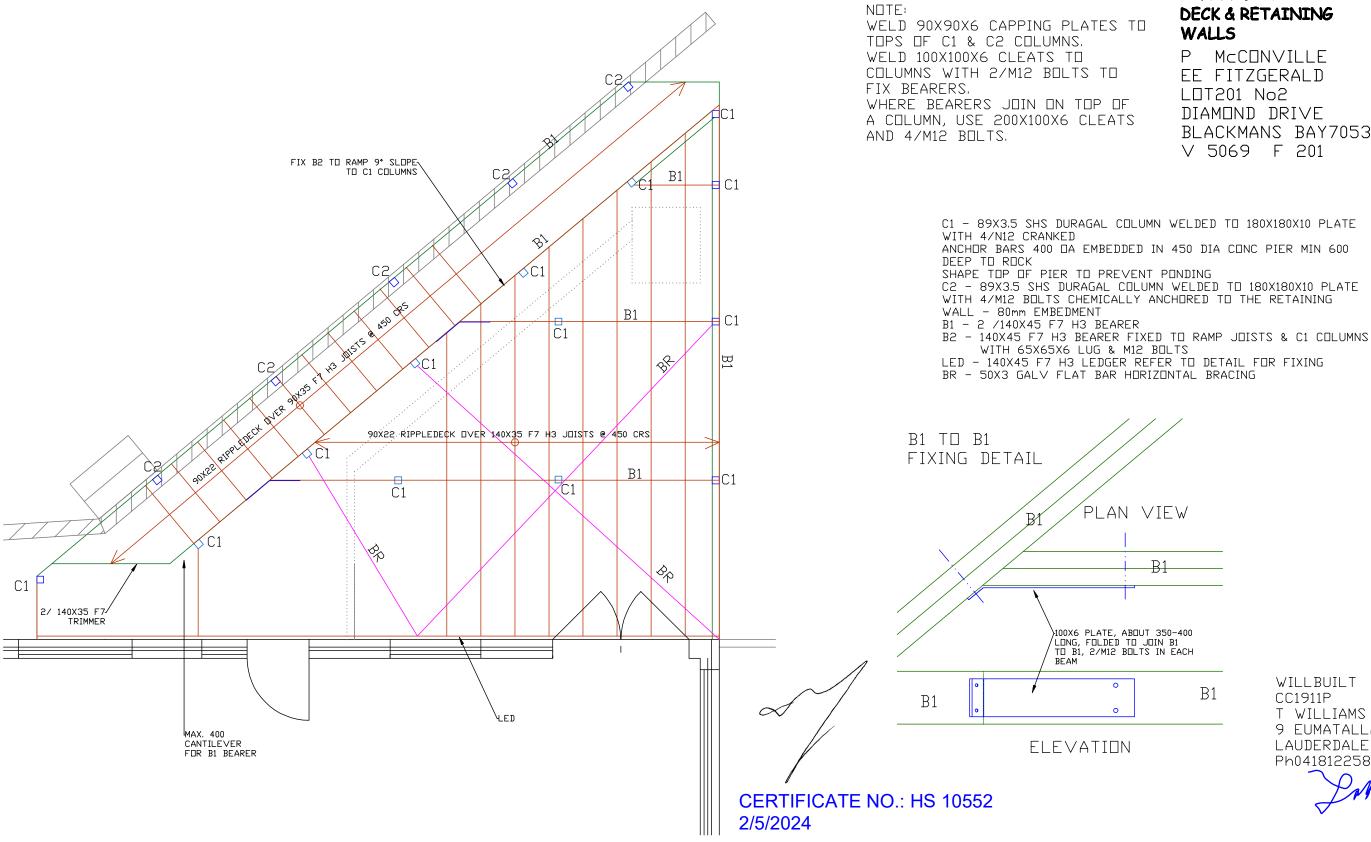BR - 50X3 GALV FLAT BAR HORIZONTAL BRACING

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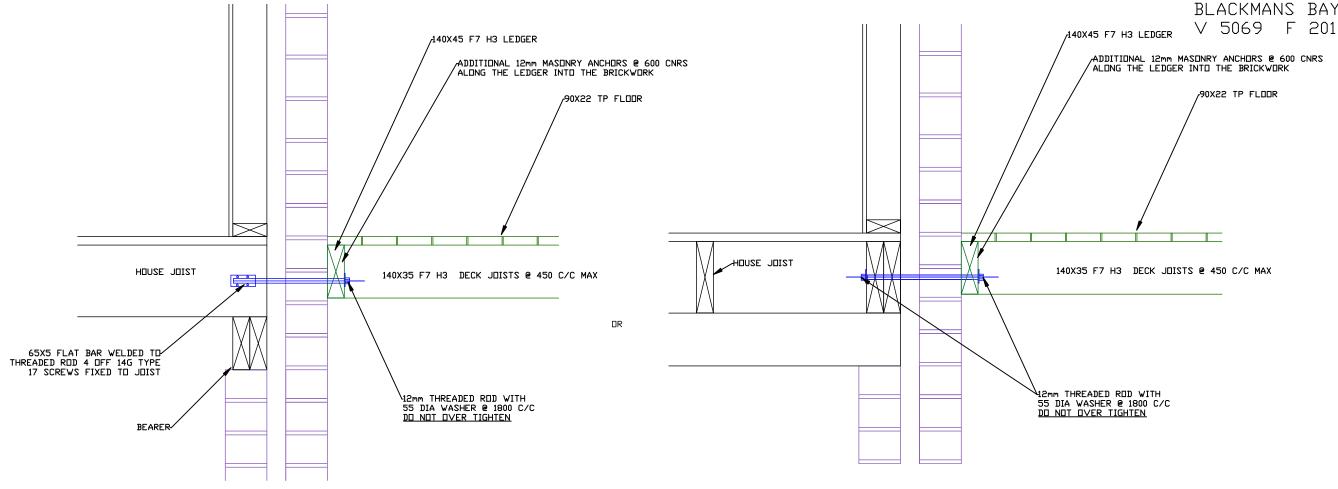
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ADDITIONAL 12mm MASONRY ANCHORS @ 600 C/C ALONG THE LEDGER INTO THE BRICK WORK SCALE: 1:10
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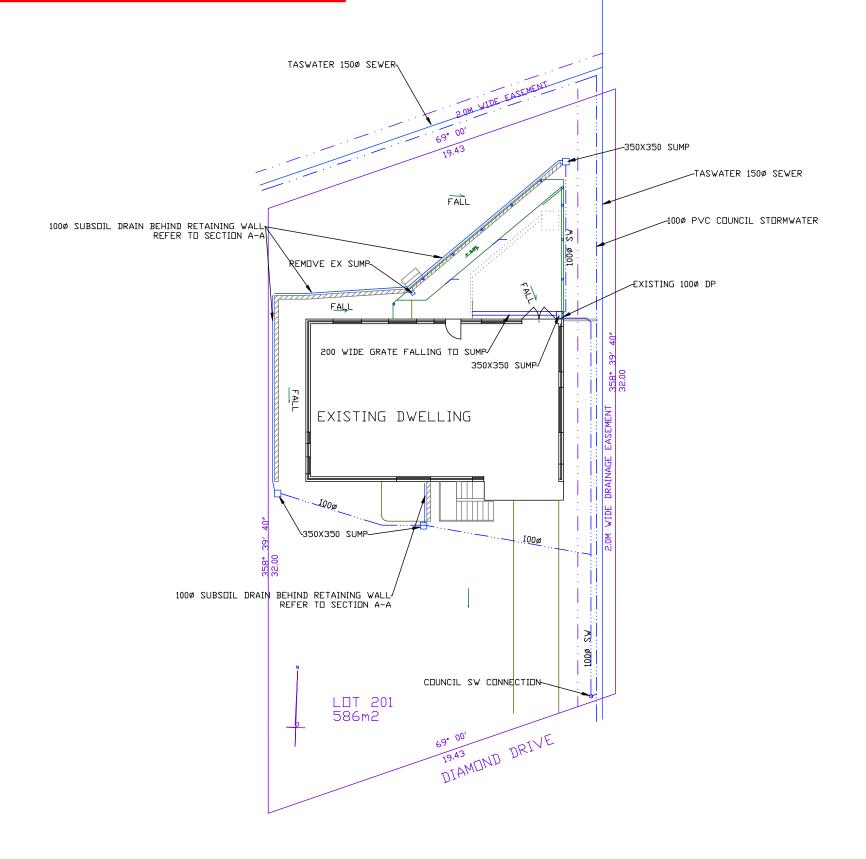
DECK TO HOUSE ATTACHMENT BLOCK VENEER



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WASTE PLUMBING DIAGRAM

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