APPLICATION FOR PLANNING APPROVAL

Application Number: DA-2024-309

Proposal: Seven (7) multiple dwellings

Subject Site: 2, 4, 6, 8, 10 & 12 Cassytha Close and 67 & 518

Village Drive, Kingston

Responsible Planning Officer: Camilo Miranda

Advertised Documents:

Application Plans

• Bushfire Hazard Assessment

Available upon request:

- Application Form
- Copy of Title

NOTE: The documents included for advertising (public notice) have been provided by the applicant. The advertising of the documentation does not confirm that Council agrees with, or endorses, the content or assessments.

Representations:

Representations must be provided in writing to Council stating the reasons why you support or object to the application. Representations for this application must be submitted by 11.59pm on **3 December 2024**; and can be delivered in person to the Civic Centre, posted to Locked Bag 1, Kingston 7050 or emailed to kc@kingborough.tas.gov.au.



Kingborough Council

Development Application: DA-2024-309
Plan Reference No: P2
Date Received: 13/11/2024
Date placed on Public Exhibition: 20/11/2024



DEVELOPMENT APPLICATION

4 VILLAGE DRIVE KINGSTON TAS 7050

CASSYTHA CLOSE MULTI-UNIT DEVELOPMENT

ID	LAYOUT	REV	ID	LAYOUT	REV	ID	LAYOUT	REV
	COVER		L45-A101	SITE PLAN & CONTEXT		L43-A105	ELEVATION 01	
A001	NOTES & SITE LOCATION		L45-A102	GROUND FLOOR PLAN		L43-A106	ELEVATION 02	
A002	SITE PLAN LOT 44-46		L45-A103	FIRST FLOOR PLAN		L43-A107	WINDOW & DOOR SCHEDULE	
A003	SITE PLAN LOT 42-43		L45-A104	ROOF PLAN		L42-A101	SITE PLAN & CONTEXT	
A004	SITE PLAN LOT 40-41	Α	L45-A105	ELEVATION 01	Α	L42-A102	GROUND FLOOR PLAN	
A005	SITE ELEVATION L45&L46	А	L45-A106	ELEVATION 02		L42-A103	FIRST FLOOR PLAN	
A006	SITE ELEVATION L44&L45		L45-A107	WINDOW & DOOR SCHEDULE		L42-A104	ROOF PLAN	
A007	SITE ELEVATION L43&L44		L44-A101	SITE PLAN & CONTEXT		L42-A105	ELEVATION 01	
A008	SITE ELEVATION L41&L42	A	L44-A102	GROUND FLOOR PLAN		L42-A106	ELEVATION 02	А
A009	SITE ELEVATION L40&L41	Α	L44-A103	FIRST FLOOR PLAN		L42-A107	WINDOW & DOOR SCHEDULE	
L46-A101	SITE PLAN & CONTEXT GF		L44-A104	ROOF PLAN		L41-A101	SITE PLAN & CONTEXT GF	
L46-A102	SITE PLAN & CONTEXT FF	А	L44-A105	ELEVATION 01		L41-A102	SITE PLAN & CONTEXT FF	Α
L46-A103	GROUND FLOOR PLAN		L44-A106	ELEVATION 02		L41-A103	GROUND FLOOR PLAN	
L46-A104	FIRST FLOOR PLAN		L44-A107	WINDOW & DOOR SCHEDULE		L41-A104	FIRST FLOOR PLAN	
L46-A105	ROOF PLAN		L43-A101	SITE PLAN & CONTEXT		L41-A105	ROOF PLAN	
L46-A106	ELEVATION 01	А	L43-A102	GROUND FLOOR PLAN		L41-A106	ELEVATION 01	Α
L46-A107	ELEVATION 02		L43-A103	FIRST FLOOR PLAN		L41-A107	ELEVATION 02	
L46-A108	WINDOW & DOOR SCHEDULE		L43-A104	ROOF PLAN		L41-A108	WINDOW & DOOR SCHEDULE	


ID	LAYOUT	REV
L40-A101	SITE PLAN & CONTEXT GF	
L40-A102	GROUND FLOOR PLAN	Α
L40-A103	FIRST FLOOR PLAN	
L40-A104	ROOF PLAN	
L40-A105	ELEVATION 01	
L40-A106	ELEVATION 02	
L40-A107	WINDOW & DOOR SCHEDULE	

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GENERAL NOTES

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DO NOT SCALE FROM THIS DRAWING

THE CONTRACTOR SHALL CONFIRM ON SITE EXISTING CONDITIONS,

ALL DISCREPANCIES TO BE REPORTED TO THE ARCHITECT FOR

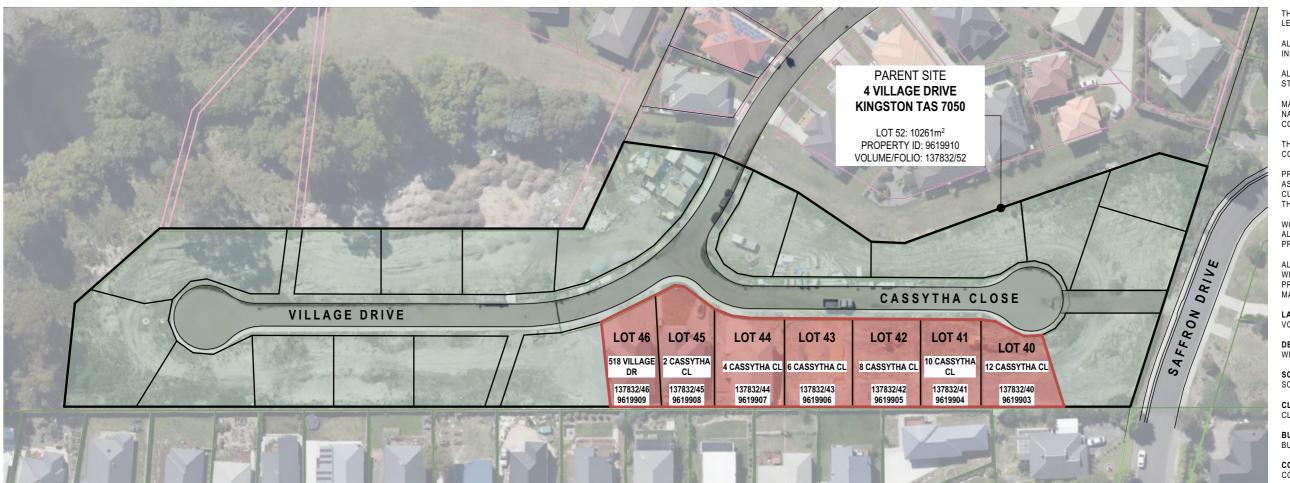ALL LEVELS INDICATED PERTAIN TO FINISHED LEVELS AND NOT STRUCTURAL LEVELS UNLESS OTHERWISE INDICATED

MATERIALS AND WORK PRACTICES SHALL COMPLY WITH THE NATIONAL CONSTRUCTION CODE (NCC) AND OTHER RELEVANT CODES REFERRED TO IN THE NCC

THIS DRAWING IS TO BE READ IN CONJUNCTION WITH ALL OTHER CONTRACT DOCUMENTS, SPECIFICATIONS AND DRAWINGS

PROPRIETARY ITEMS, SYSTEMS AND ASSEMBLIES ARE TO BE ASSEMBLED, INSTALLED OR FIXED IN CONFORMANCE WITH THE CURRENT WRITTEN RECOMMENDATIONS AND INSTRUCTIONS OF THE MANUFACTURER OR SUPPLIER

WORKPLACE HEALTH AND SAFETY ALL DRAWINGS ARE TO BE READ IN CONJUNCTION WITH THE

ALL CONTRACTORS MUST CARRY OUT WORKS IN ACCORDANCE WITH CURRENT HEALTH AND SAFETY LEGISLATION AND BEST PRACTICE INCLUDING PREPARATION OF A CONSTRUCTION SAFETY MANAGEMENT PLAN

LAND TITLE REFERENCE

DESIGN WIND SPEED

SOIL CLASSIFICATION SOIL CLASSIFICATION TO AS 2870: S

CLIMATE ZONE FOR THERMAL DESIGN CLIMATE ZONE TO BCA FIGURE 1.1.4: 7

BUSHFIRE PRONE AREA BAL RATING BUSHFIRE ATTACK LEVEL (BAL) TO AS 3959: BAL-12.5

CORROSION ENVIRONMENT CORROSION ENVIRONMENT TO AS/NZS 2312: N/A

KNOWN SITE HAZARDS: n/a



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SITE LOCATION PLAN

SCALE 1:1000

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Version: 1, Version Date: 18/11/2024

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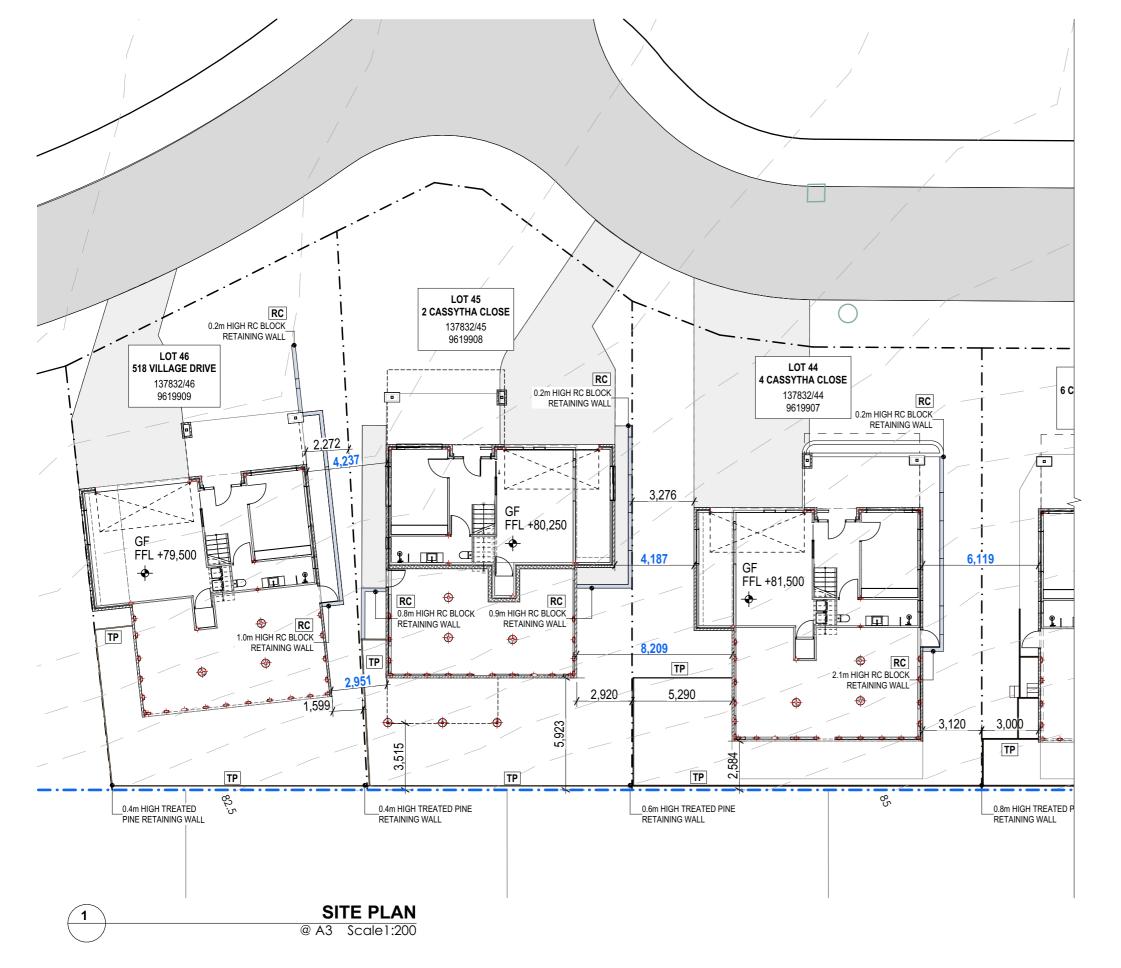
Description

PROJECT REVISION DATE SCALE CASSYTHA CLOSE 13/11/2024 AS SHOWN @ A3 4 VILLAGE DRIVE KINGSTON TAS 7050 PROJECT ID CHECKED BY DRAWN BY MORNING STAR HOLDINGS PTY LTD 2009 A.HILL J. LIM

PAGE A001


DRAWING

NOTES & SITE LOCATION



Version: 1, Version Date: 18/11/2024

LEGEND & NOTES

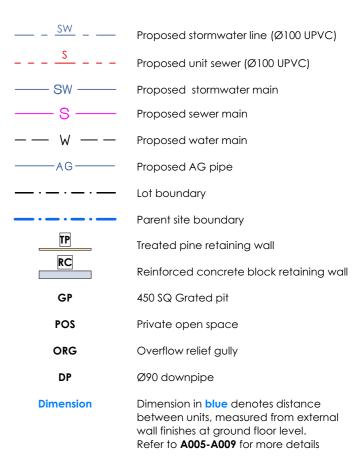

NOTE:

All driveway, parking and turning areas to be sealed with concrete and to comply with planning conditions.


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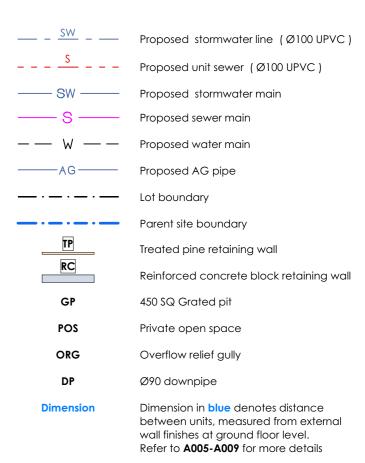
Date placed on Public Exhibition: 20/11/2024





Version: 1, Version Date: 18/11/2024

LEGEND & NOTES

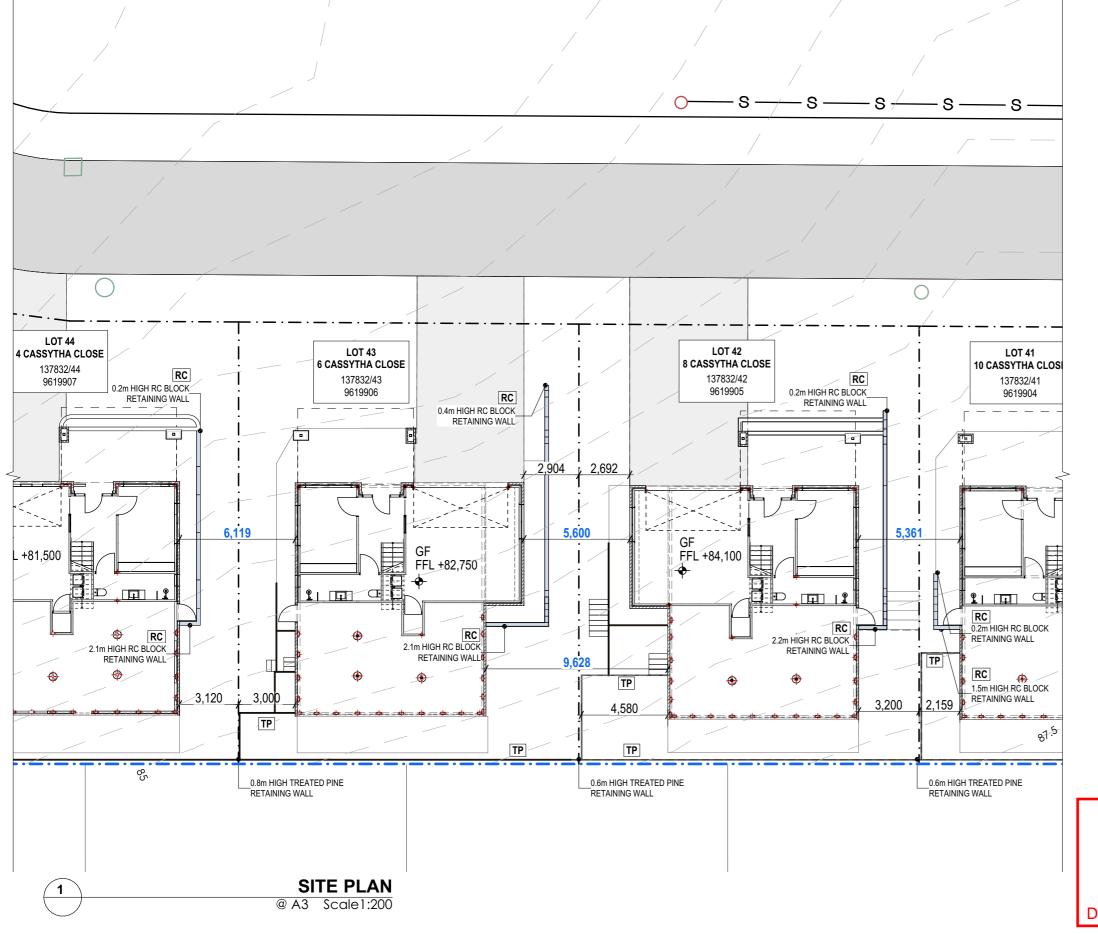


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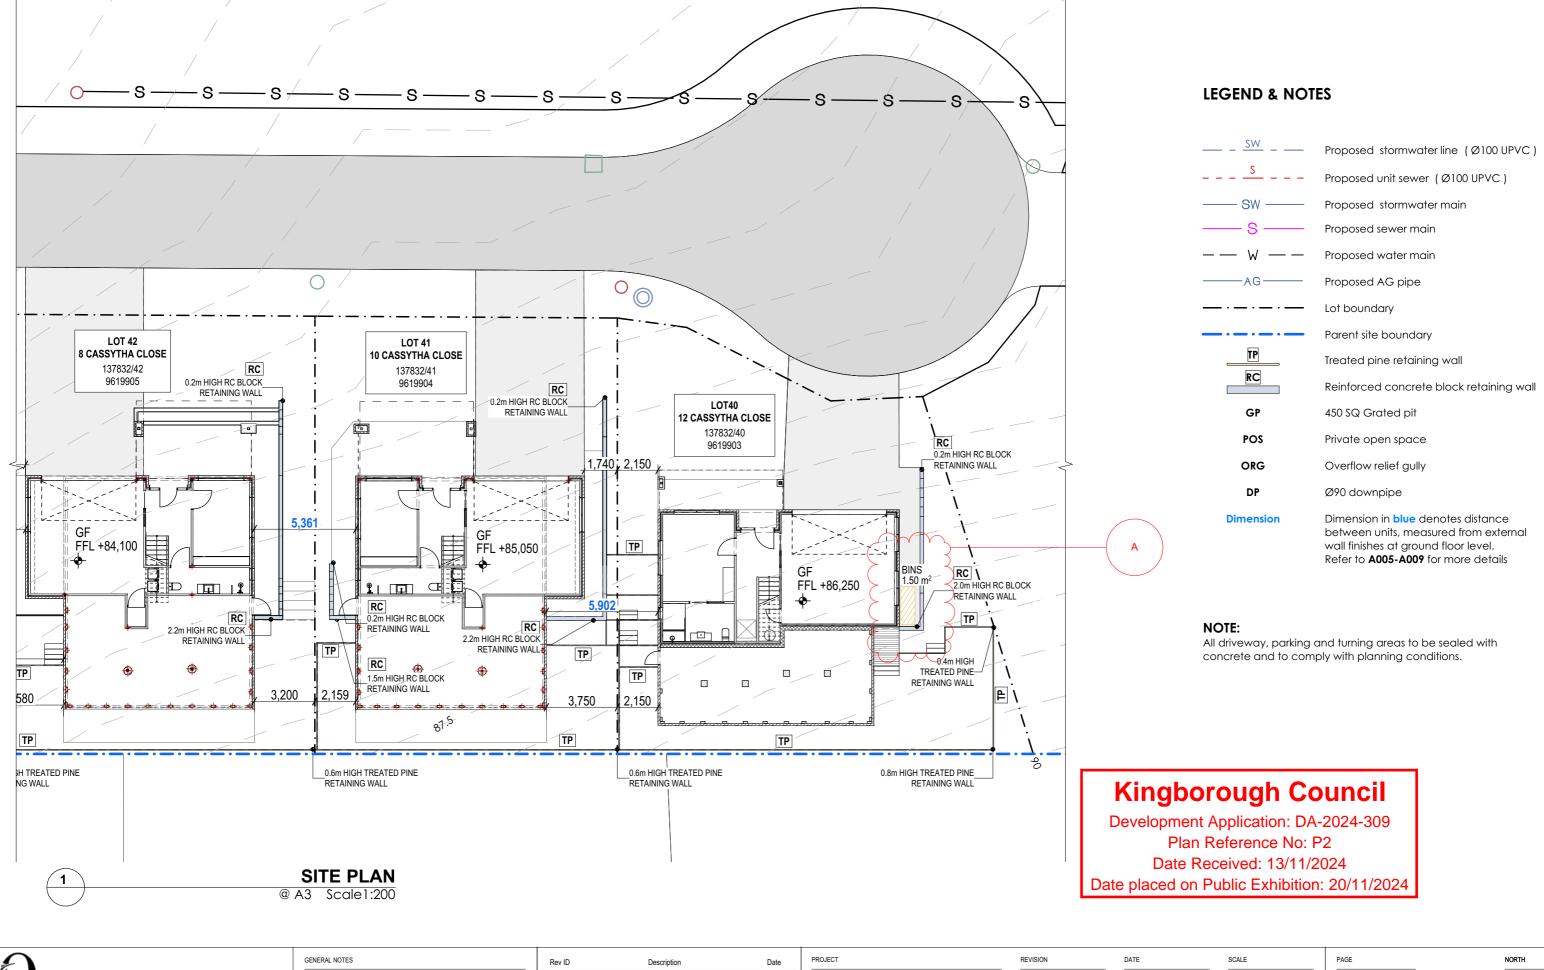
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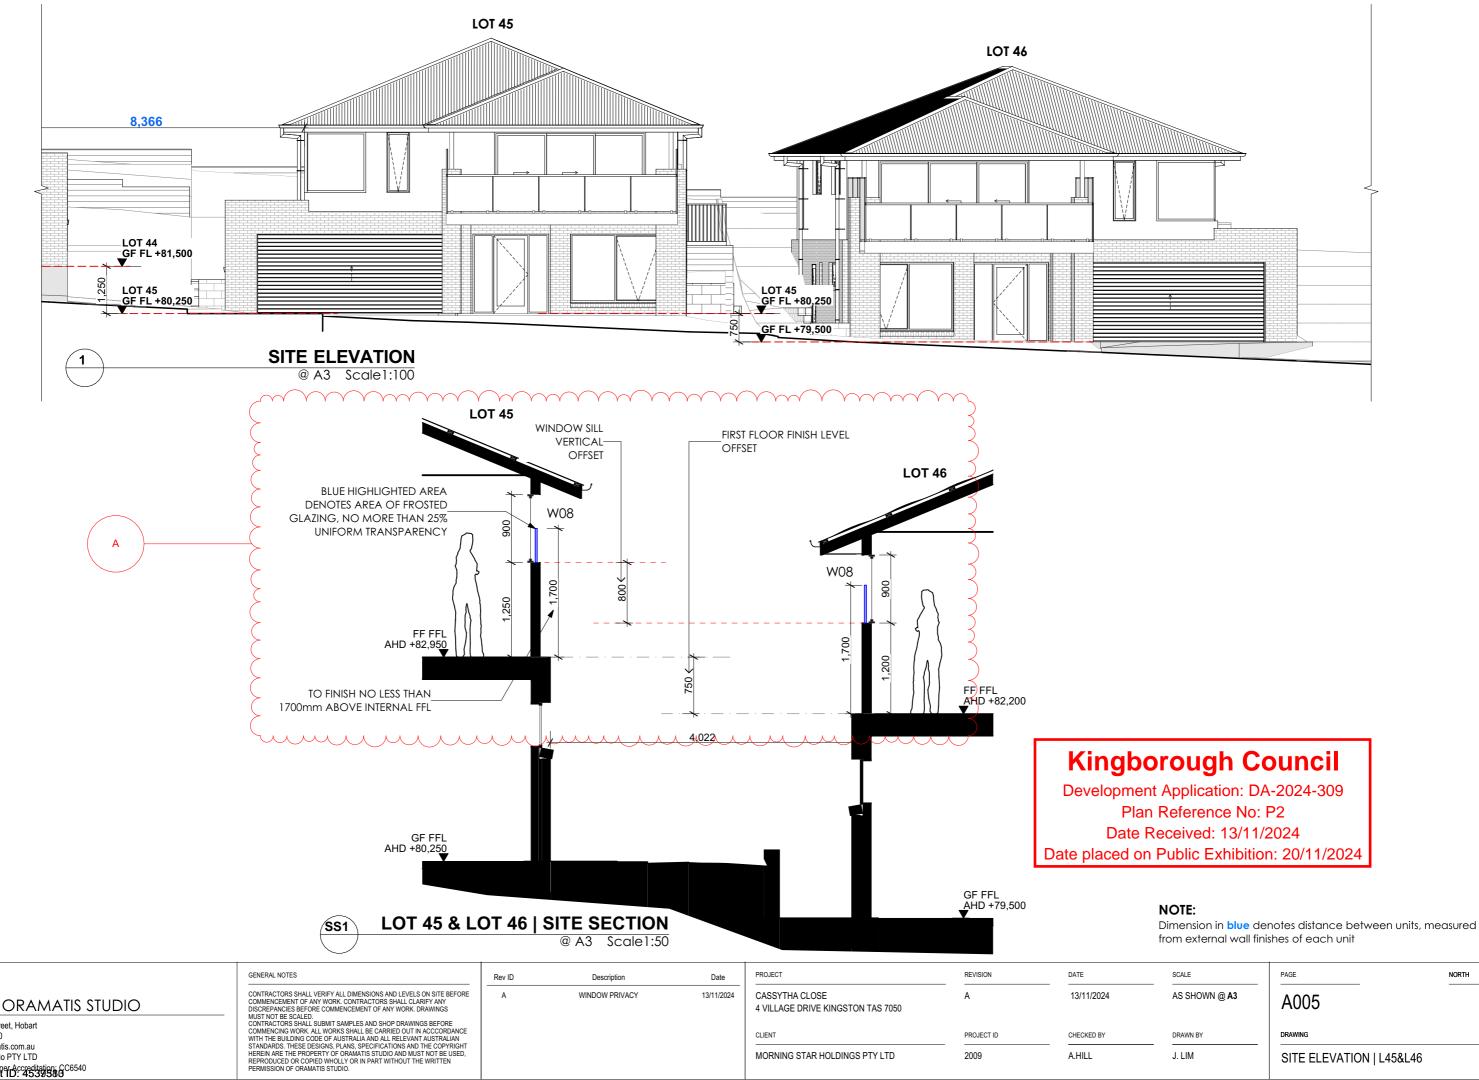
A004 DRAWING

AS SHOWN @ A3

DRAWN BY

J. LIM

SITE PLAN | LOT 40-41

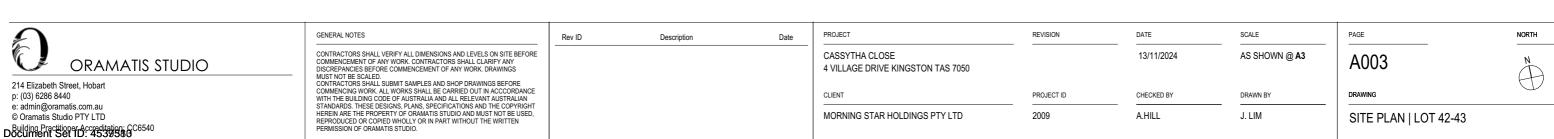


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Rev ID	Description	Date
Α	WINDOW PRIVACY	13/11/2024

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SITE ELEVATION | L45&L46

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Kingborough Council

Development Application: DA-2024-309 Plan Reference No: P2 Date Received: 13/11/2024 Date placed on Public Exhibition: 20/11/2024

NOTE:

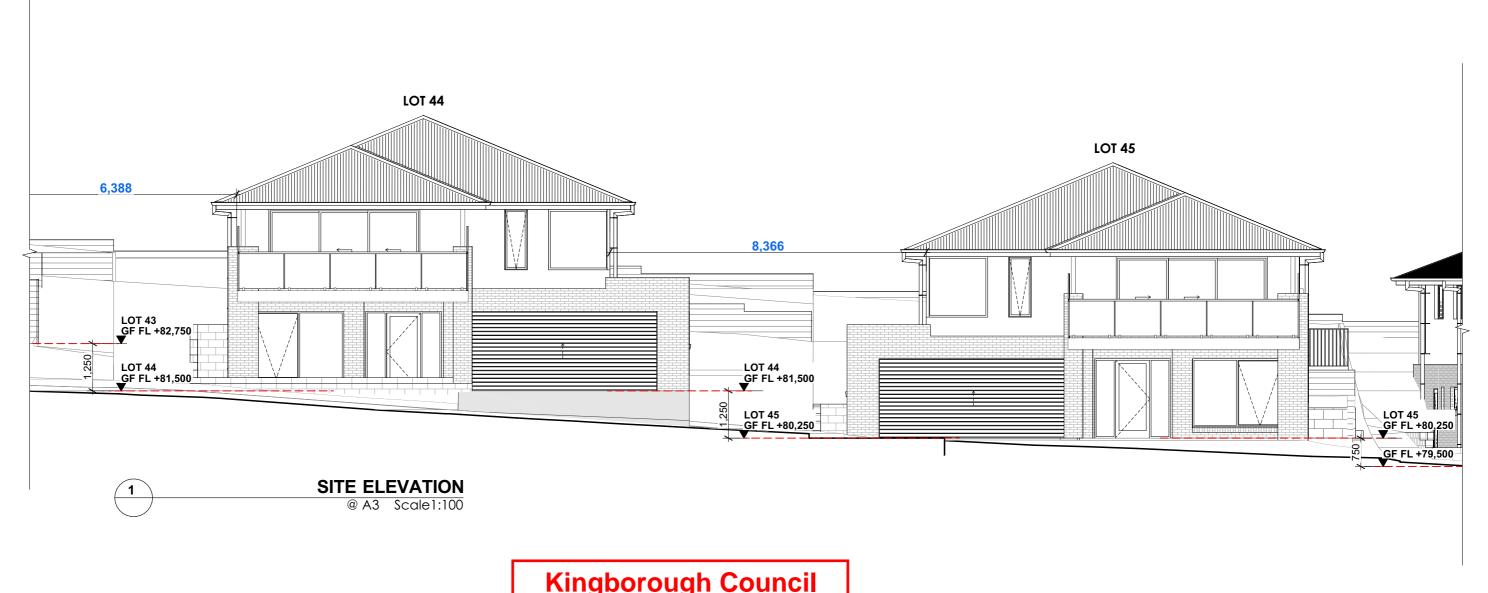Dimension in **blue** denotes distance between units, measured from external wall finishes of each unit



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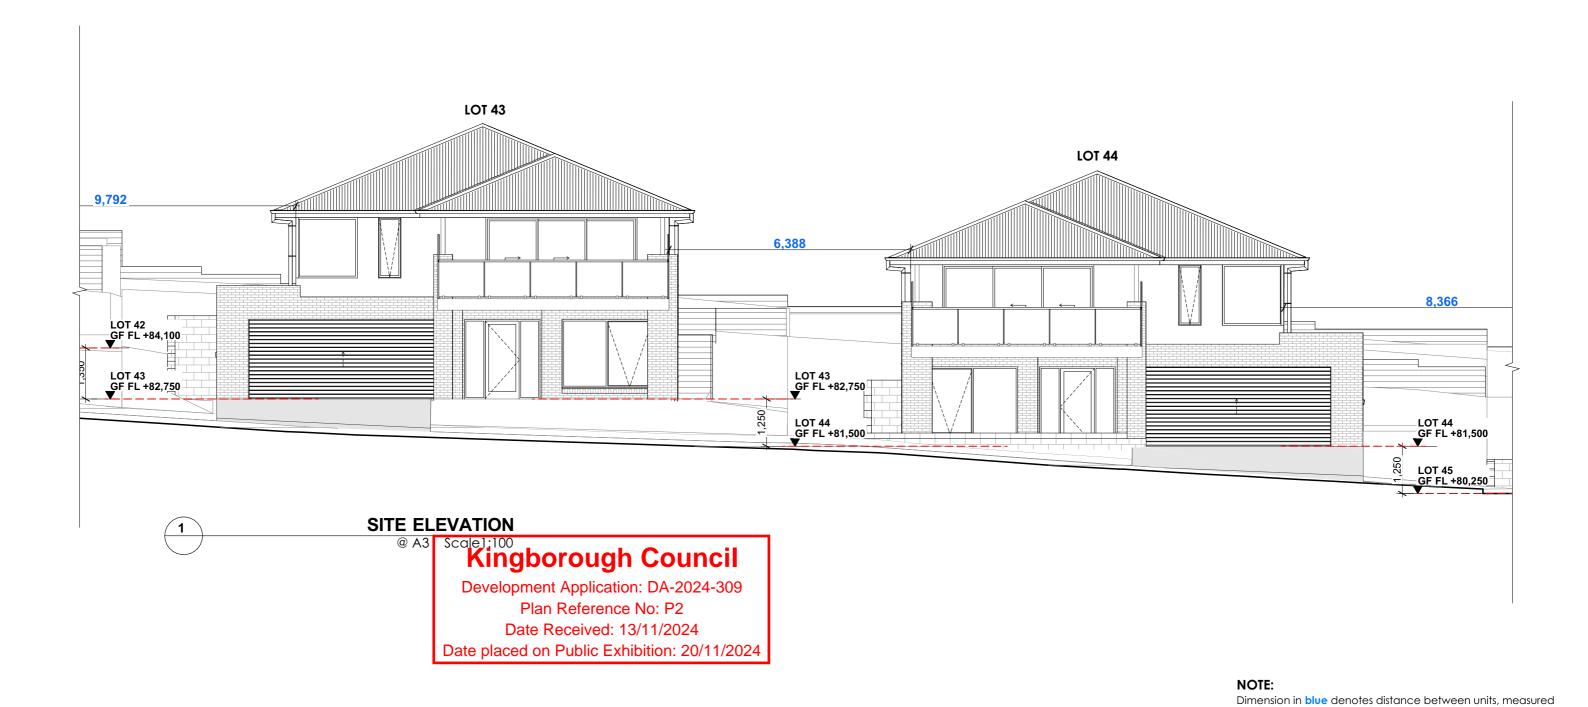
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Rev ID Descripti	on Date

PROJECT	REVISION	DATE	SCALE	F
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MORNING STAR HOLDINGS PTY LTD	2009	A.HILL	J. LIM	;

PAGE	NORTH
A006	
DRAWING	
SITE ELEVATION L44&L45	



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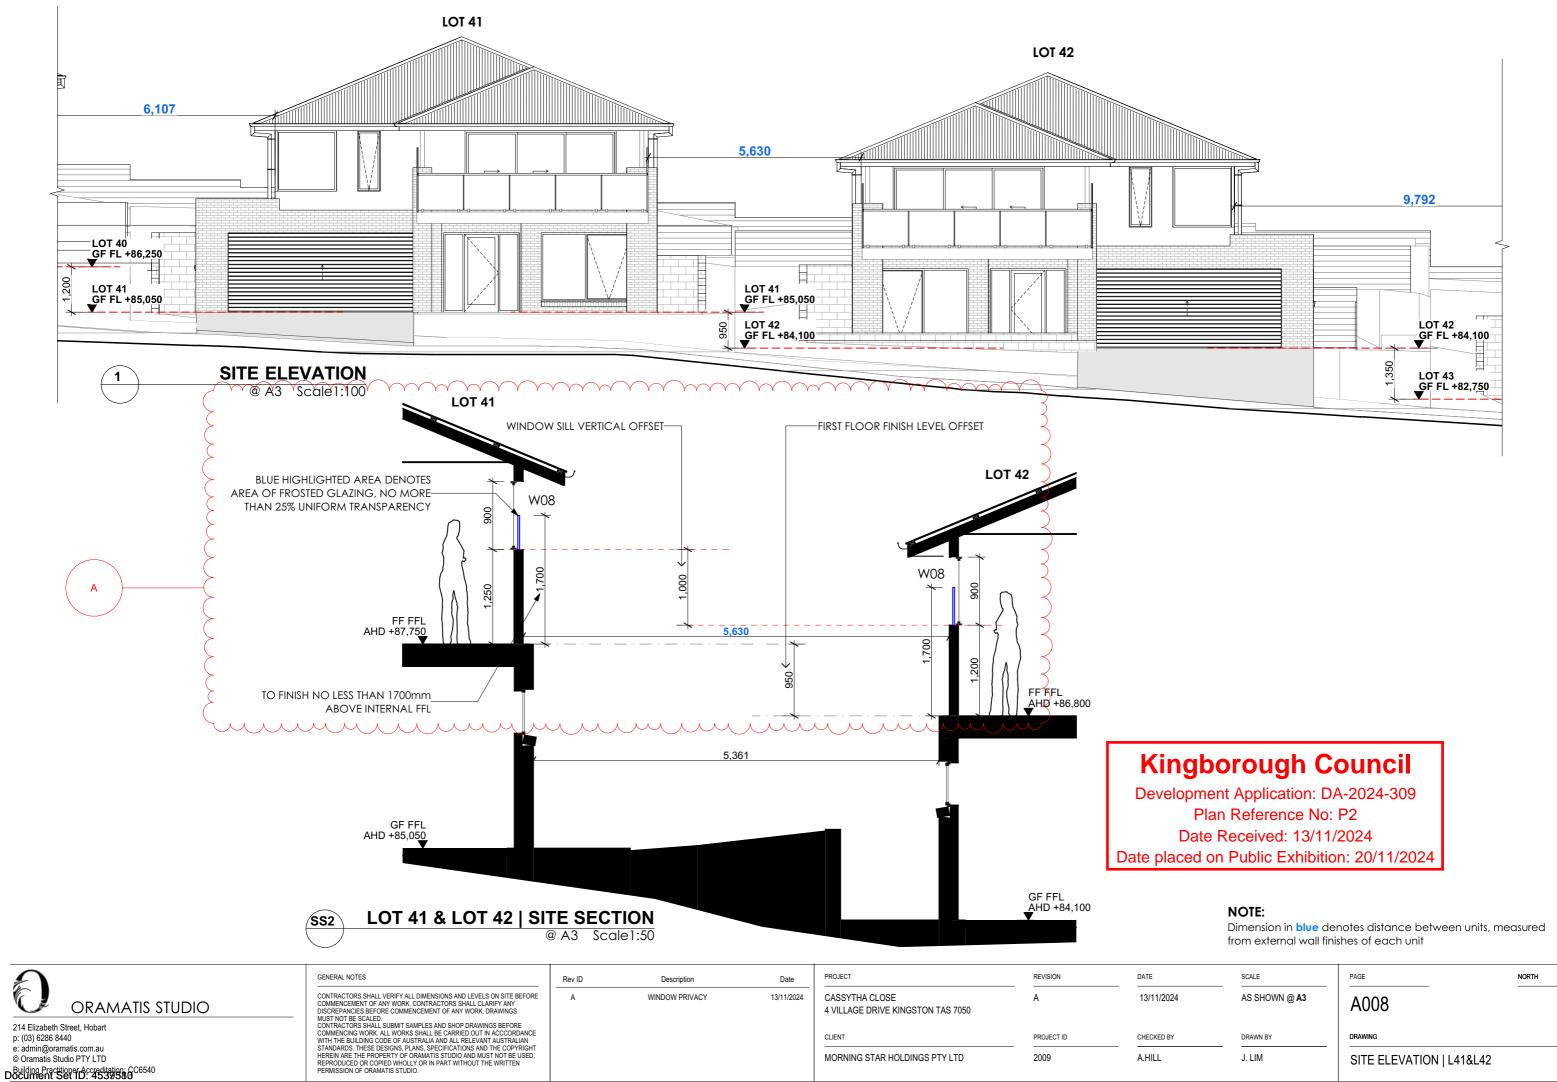
PAGE A007 SITE ELEVATION | L43&L44

from external wall finishes of each unit


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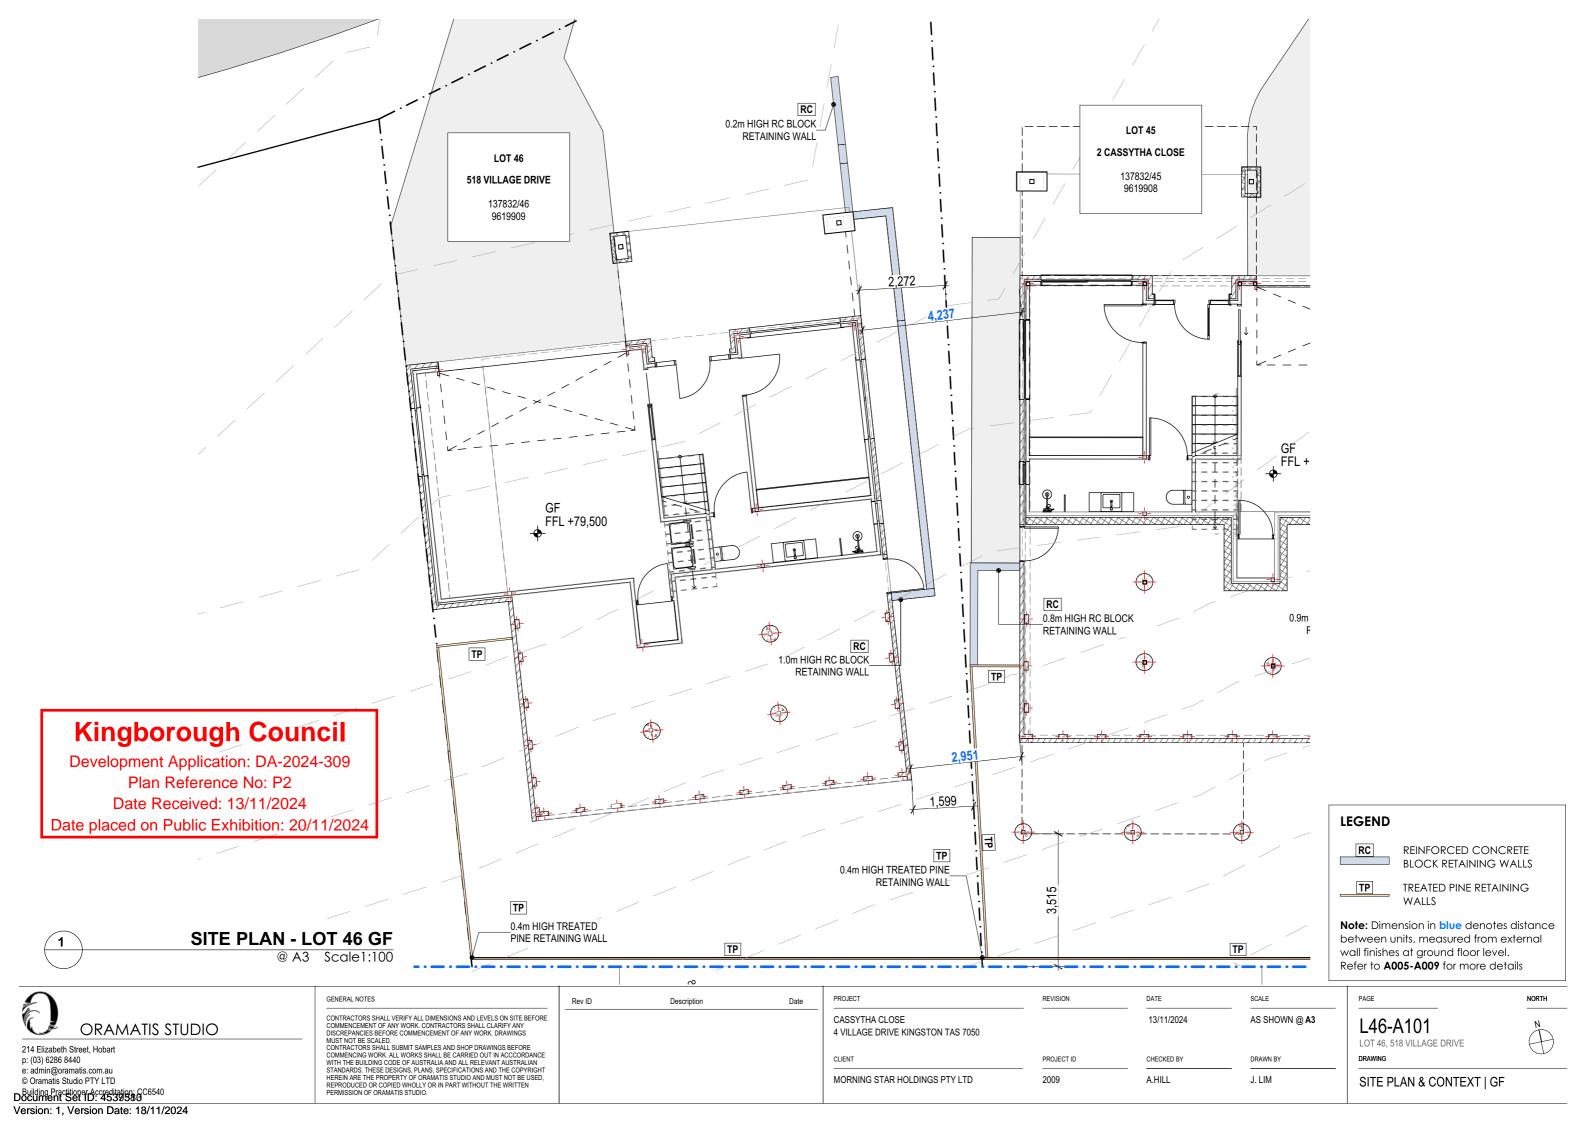
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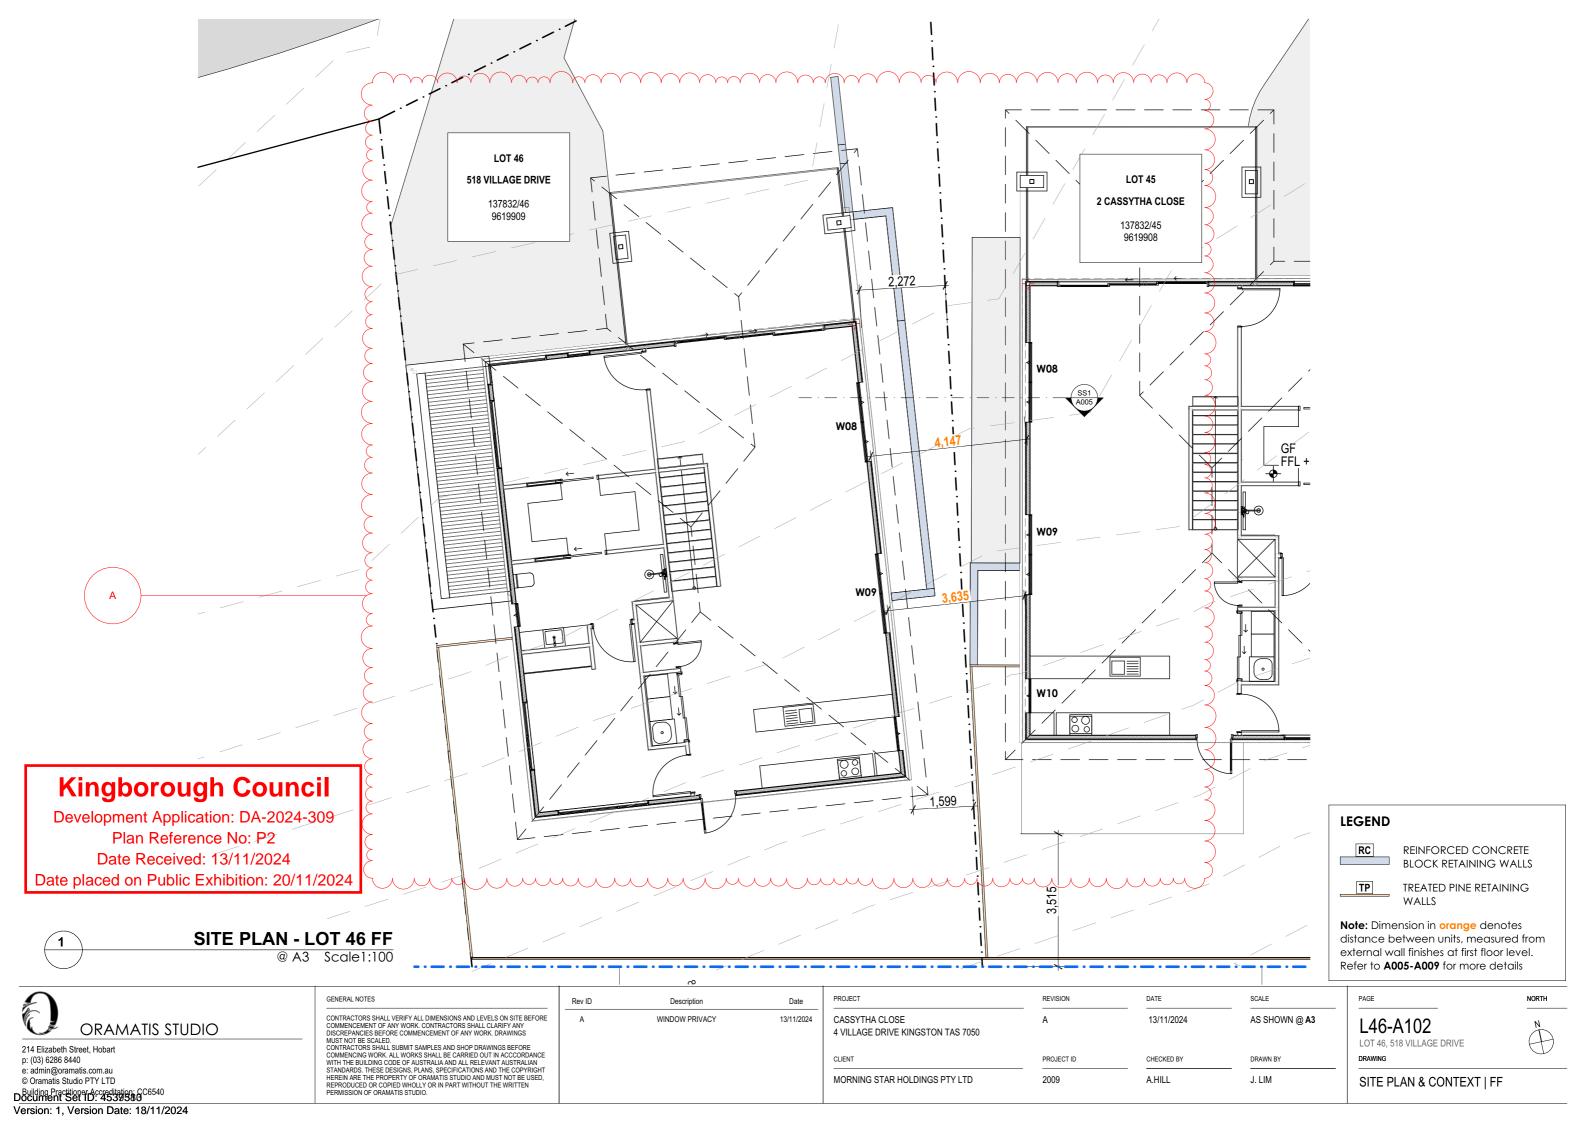



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Room List			
Room Name	Measured Area		
Bath	7.74		
BATH	6.02		
Bed 1	13.40		
Bed 2	13.71		
Deck	24.43		
Entry	7.74		
Garage	35.76		
Kitchen	30.73		
LANDING	1.00		
L'dry	2.30		
Living	31.88		
Master	12.77		
Subfloor	55.03		
WIR	7.79		
	250.30 m²		

LEGEND

TP

TREATED PINE RETAINING WALL

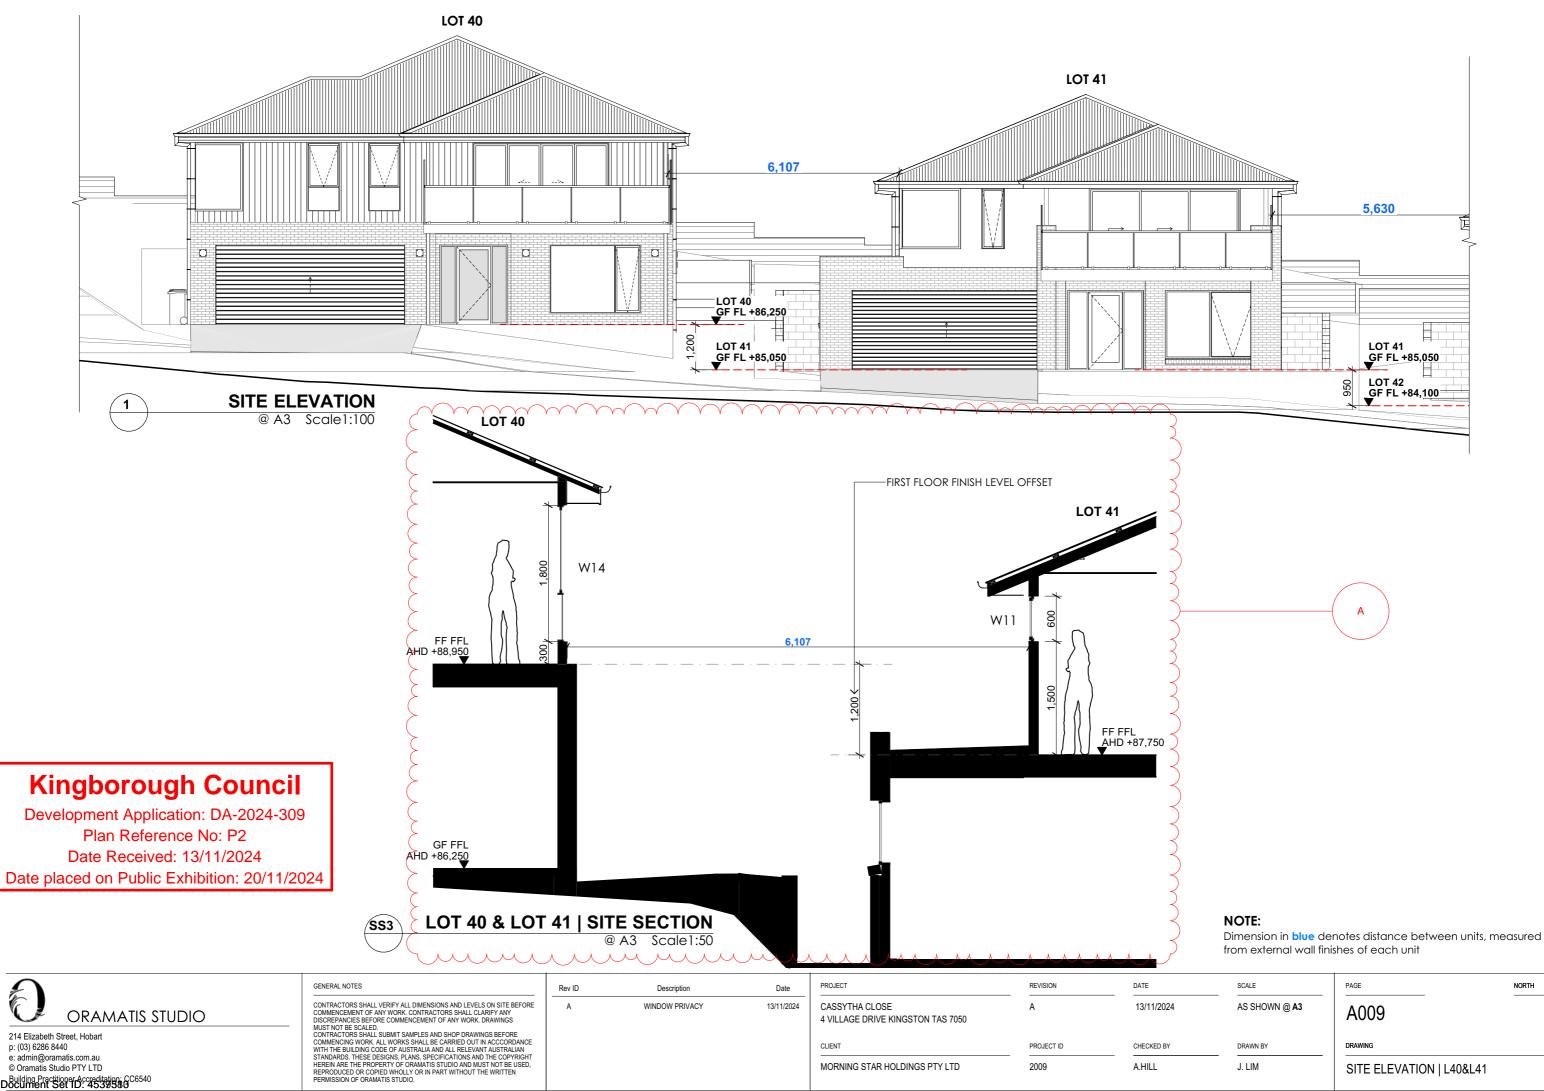REINFORCED CONCRETE BLOCK RETAINING WALL

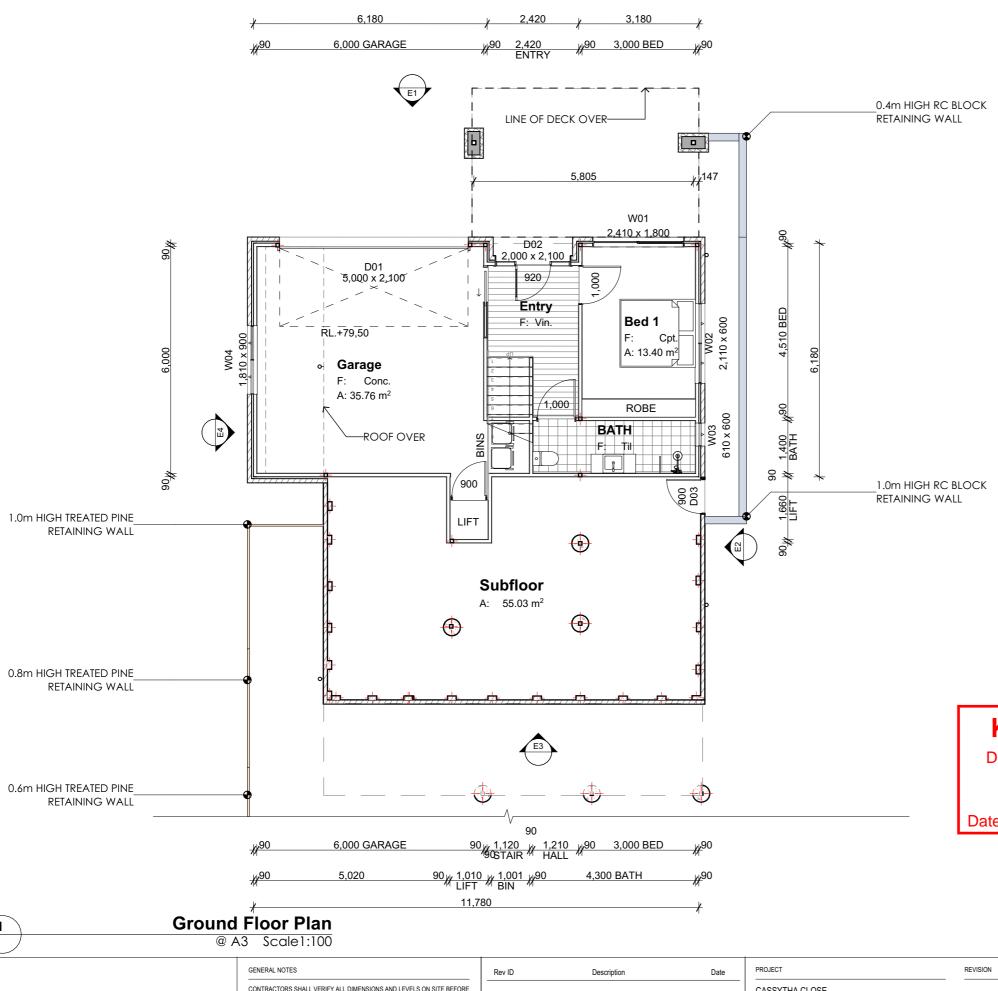nom NOMINAL

CONFIRM ON SITE

Kingborough Council

Development Application: DA-2024-309 Plan Reference No: P2 Date Received: 13/11/2024

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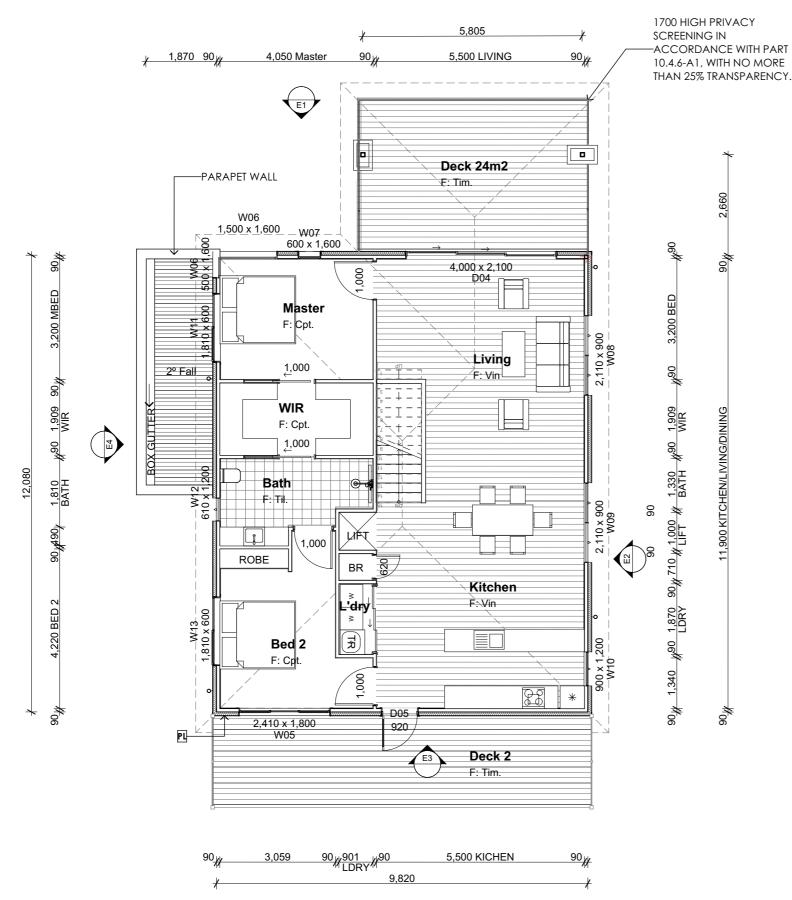
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MORNING STAR HOLDINGS PTY LTD	2009	A.HILL	J. LIM

PAGE	NORTI
L46-A103 LOT 46, 518 VILLAGE DRIVE	N A
DRAWING	<u></u>
GROUND FLOOR PLAN	



Room List			
Room Name	Measured Area		
Bath	7.74		
BATH	6.02		
Bed 1	13.40		
Bed 2	13.71		
Deck	24.43		
Entry	7.74		
Garage	35.76		
Kitchen	30.73		
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L'dry	2.30		
Living	31.88		
Master	12.77		
Subfloor	55.03		
WIR	7.79		
	250.30 m²		

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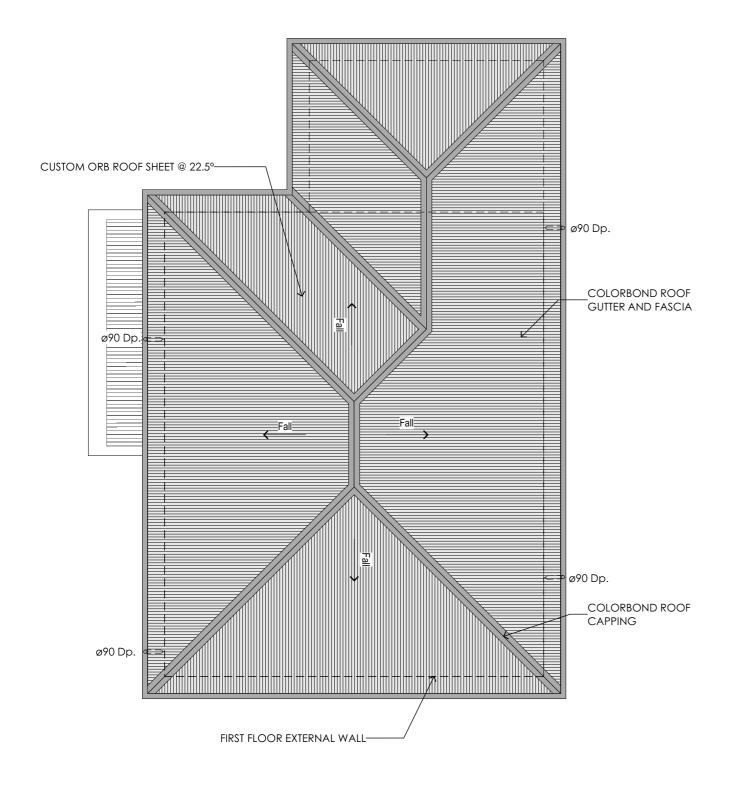
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PAGE	NORT
L46-A104 LOT 46, 518 VILLAGE DRIVE	Ä
DRAWING	
FIRST FLOOR PLAN	

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Roof Plan @ A3 Scale1:100



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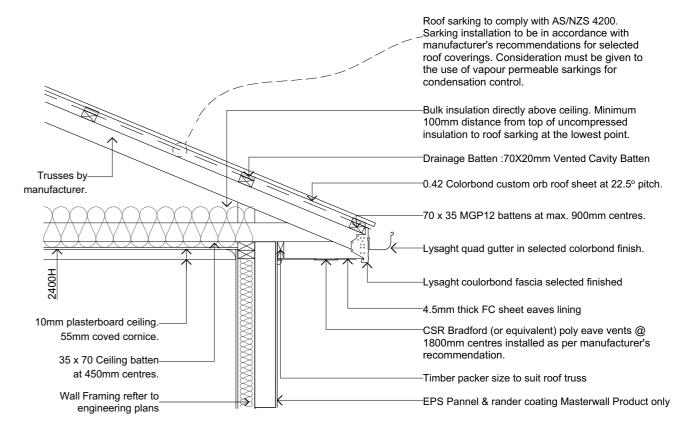
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LEGEND & NOTES

Downpipe 90dia PVC downpipe

1. GUTTERS MUST BE INSTALLED WITH A FALL OF NOT LESS THAN 1:500 FOR EAVES GUTTERS, UNLESS FIXED TO METAL FASCIAS; AND 1:100 FOR



ROOF CONDENSATION CONTROL DETAIL

Kingborough Council


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AS3500.3 - STORMWATER DRAINAGE				
Rc	Roof Catchment Area	195.81m2		
	Roof Pitch	22.5 deg Rc x 1.21 slope factor = 236.93m2 (TABLE 3.2)		
	Design Rainfall (100yr 5 min Duration)	116L/s (NCC Vol 2 Part 3.5.2.5)		
	Downpipe Crossection	90dia - 6400 - (TABLE 3.3)		
С	Max Catchment Area per Downpipe	64m2 (FIG 3.5 (A))		
	Number Downpipes Required	Rp / C = 3.70		
	Number Downpipes Provided	4 (rounded up)		

NORTH
N (





LEGEND & NOTES

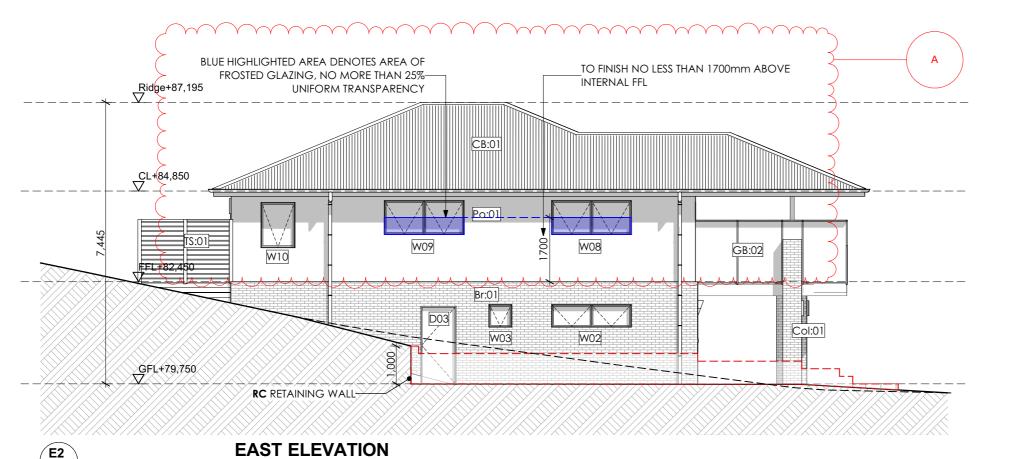DP. Downpipe

FL. Floor level

CL. Ceiling level

Face brickwork Br:01

CB:01 Colorbond roof

Glass balustrade, min. 1,000mm high to comply with AS1288. 40dia. S/S handrail and verticals, supplied as a complete approved system with toughened glass and securely fixed to perimeter PFC. The complete system must be capable of bearing loading forces according to AS 1170.1

Glass privacy screen min. 1,700mm high to comply with AS1288. 40dia. S/S handrail and verticals, supplied as a complete approved system with toughened glass and securely fixed to perimeter PFC. The complete system must be capable of bearing loading forces according to AS 1170.1 No more than 25% transparency

Powdercoated aluminium window / door frames

Colour: Basalt.

TD:01 Timber framed deck

Easylap cement sheet

Conc:01 Concrete driveway

190 series concrete block retaining wall

Col:01 rendered 100 series block column

TS:01 Timber screen

Fibre cement sheet cladding Render finish

CJVertical articulation joints as shown or not more than 5m

FE 1m high timber screen

Treated pine retaining wall

RC Reinforced concrete block retaining wall

NGL

Kingborough Council

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@ A3 Scale1:100


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Rev ID	Description	Date
Α	WINDOW PRIVACY	13/11/2024

PROJECT	REVISION	DATE	SCALE	PA
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CLIENT	PROJECT ID	CHECKED BY	DRAWN BY	DF
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PAGE	NORTH
L46-A106 LOT 46, 518 VILLAGE DRIVE	
DRAWING	
ELEVATION 01	





LEGEND & NOTES

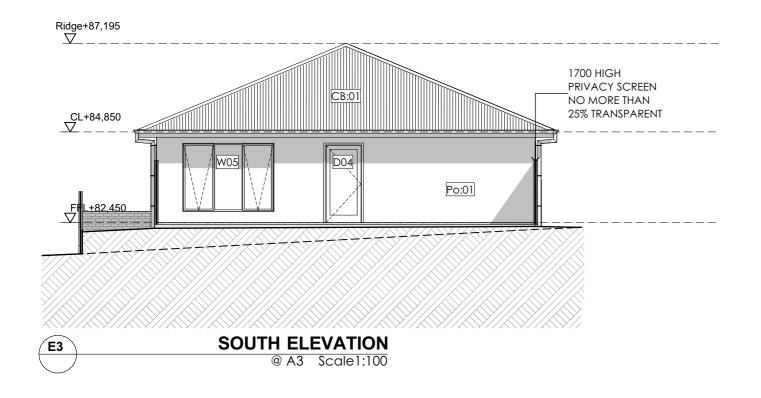DP. Downpipe

FL. Floor level

CL. Ceiling level

Face brickwork Br:01

CB:01 Colorbond roof

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Conc:01 Concrete driveway

190 series concrete block retaining wall

Col:01 rendered 100 series block column

TS:01 Timber screen

Fibre cement sheet cladding Render finish FC:01

CJVertical articulation joints as shown or not more than 5m

FE 1m high timber screen

Treated pine retaining wall

RC Reinforced concrete block retaining wall

NGL

Kingborough Council

Development Application: DA-2024-309 Plan Reference No: P2 Date Received: 13/11/2024

Date placed on Public Exhibition: 20/11/2024



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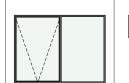
Rev ID	Description	Date

PROJECT	REVISION	DATE	SCALE
CASSYTHA CLOSE 4 VILLAGE DRIVE KINGSTON TAS 7050		13/11/2024	AS SHOWN @ A3
CLIENT	PROJECT ID	CHECKED BY	DRAWN BY
MORNING STAR HOLDINGS PTY LTD	2009	A.HILL	J. LIM

PAGE	NORTH
L46-A107 LOT 46, 518 VILLAGE DRIVE	
DRAWING	
ELEVATION 02	

Window Types

ID



W01 W x H Size 2,410×1,800 300 Awing

Sill Height Opening Type Powdercoated Aluminium Notes Frame.Double alazina



glazing

Powdercoated Aluminium Frame.Double



Aluminium

glazing

Frame.Double

W04 1,810×900 1,200 Awing Powdercoated Aluminium Frame.Double

glazing



W05 2,410×1,800 300 Awing Powdercoated

Aluminium

glazing

Frame.Double



W06

500 Frame.Double glazing

W06



W07 500

600×1,600













W12 610×1,200 900 Awing Powdercoated Aluminium

Frame.Double

glazing

500×1,600 500 Fixed conner Powdercoated Aluminium

glazing

1,500×1,600 Fixed conner Powdercoated Aluminium Frame.Double

Fixed conner Powdercoated Aluminium Frame.Double alazina

1,250 Awing Powdercoated Aluminium Frame.Double alazina

W08

2.110×900

1,250 Awing Powdercoated Aluminium Frame.Double alazina

W09

2,110×900

Awing <Undefined>

900×1,200

W10

900


Awing Powdercoated Aluminium Frame.Double alazina

1,810×600


W11

1,500

Window Types

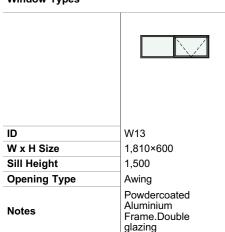




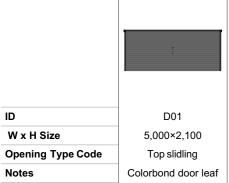




D02 2,000×2,100 Swing Double glazing

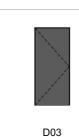

900×2,040 Swing Solid leaf paint finish

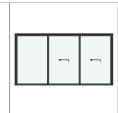

D04 4,000×2,100 Sliding Double glazing



Kingborough Council

Development Application: DA-2024-309 Plan Reference No: P2 Date Received: 13/11/2024

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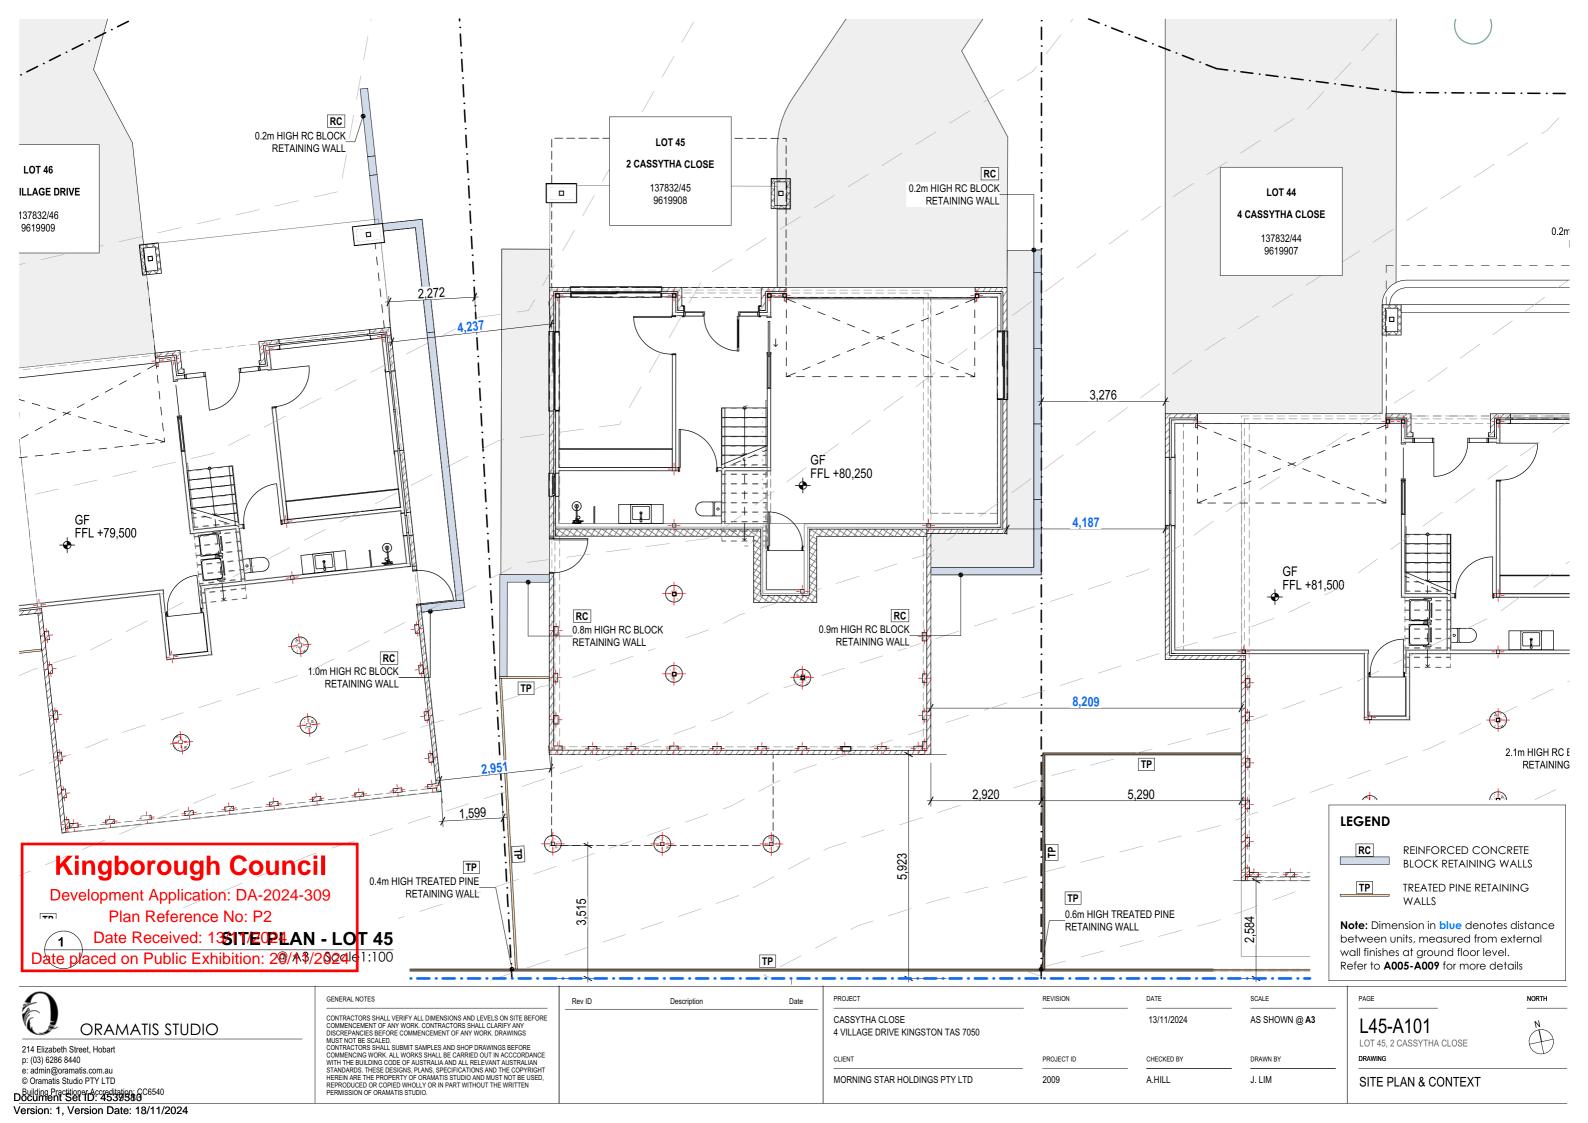
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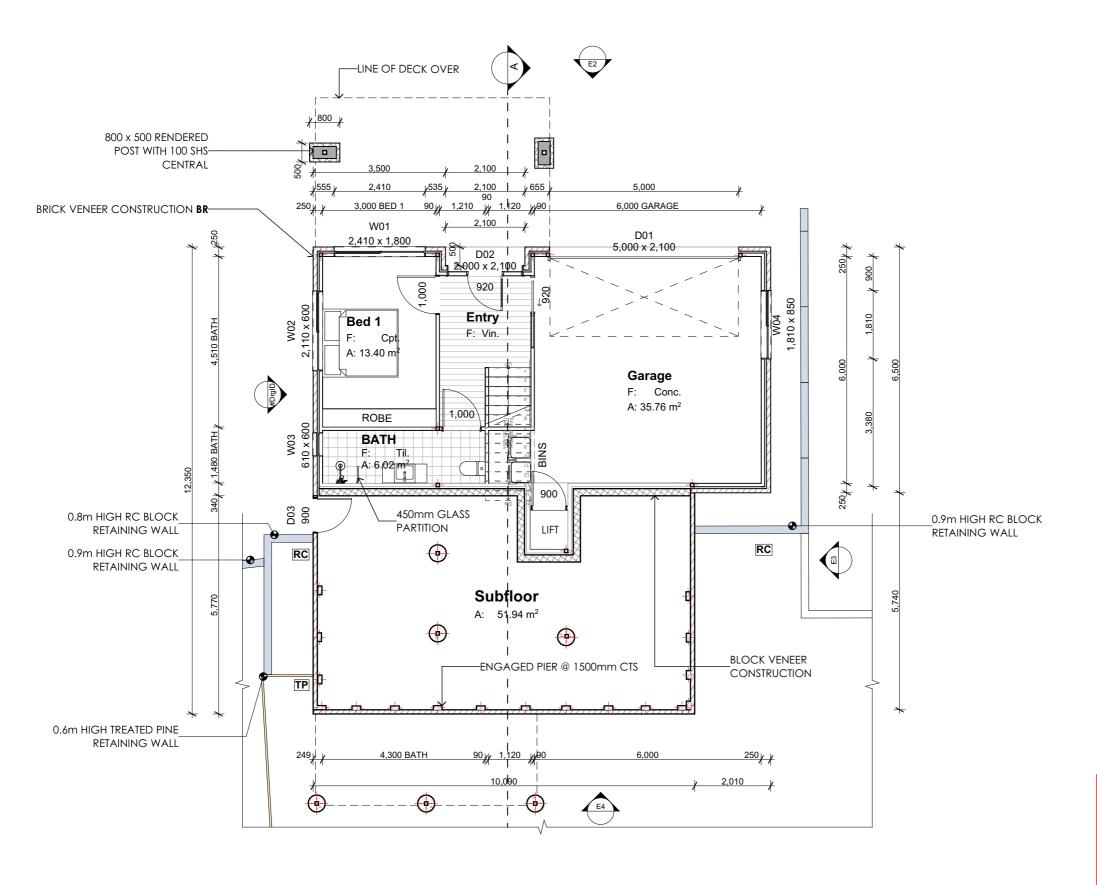
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Description	Date	PROJECT
		CASSY 4 VILL
		CLIENT
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PROJECT	REVISION	DATE	SCALE
 CASSYTHA CLOSE 4 VILLAGE DRIVE KINGSTON TAS 7050		13/11/2024	AS SHOWN @ A3
CLIENT	PROJECT ID	CHECKED BY	DRAWN BY
MORNING STAR HOLDINGS PTY LTD	2009	A.HILL	J. LIM

PAGE	NORTH
L46-A108 LOT 46, 518 VILLAGE DRIVE	
DRAWING	





Room List	
Room Name	Measured Area
Bath	7.74
BATH	6.02
Bed 1	13.40
Bed 2	13.71
Deck (POS)	24.49
Entry	7.74
Garage	35.76
Kitchen	30.73
LANDING	1.77
L'dry	2.30
Living	31.88
Master	12.77
Subfloor	55.03
WIR	7.79
	251.13 m²

LEGEND

TP

TREATED PINE RETAINING WALL



REINFORCED CONCRETE BLOCK RETAINING WALL

FE

TIMBER FENCE

nom

NOMINAL

CONFIRM ON SITE

Kingborough Council

Development Application: DA-2024-309 Plan Reference No: P2 Date Received: 13/11/2024

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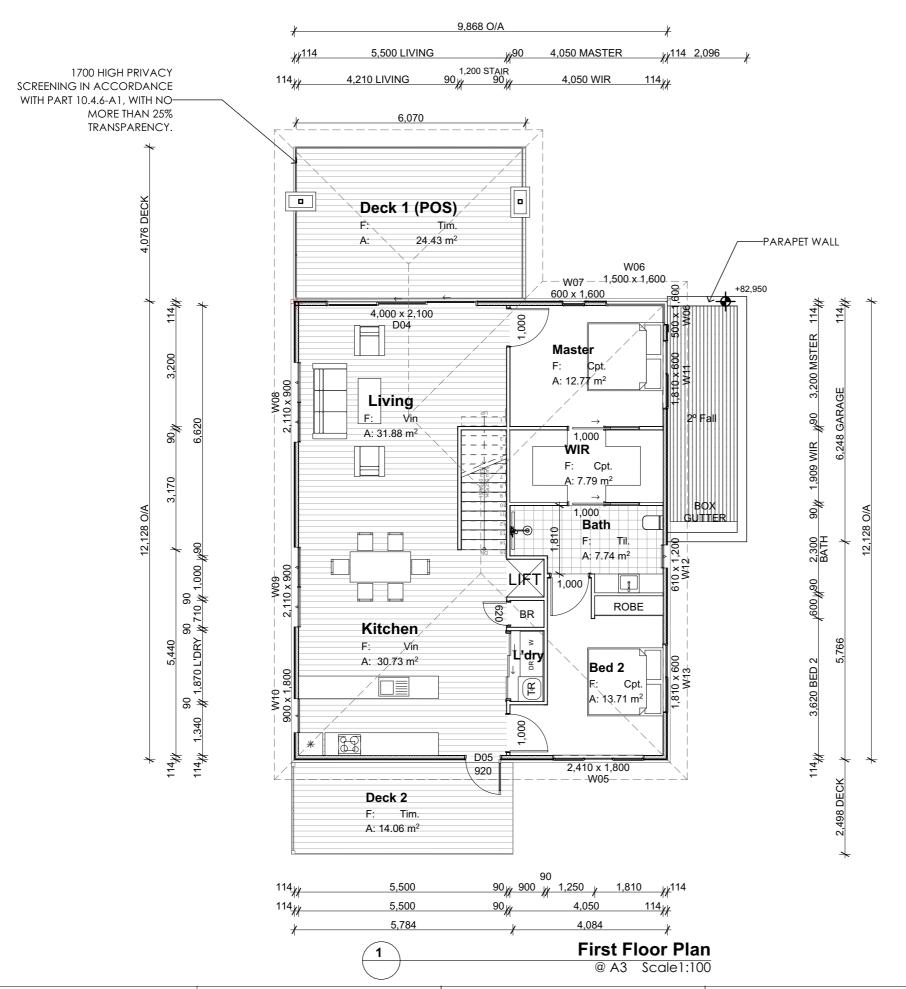
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Rev ID	Description	Date
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PROJECT	REVISION	DATE	SCALE	F
CASSYTHA CLOSE I VILLAGE DRIVE KINGSTON TAS 7050	_	13/11/2024	AS SHOWN @ A3	
CLIENT	PROJECT ID	CHECKED BY	DRAWN BY	ı
MORNING STAR HOLDINGS PTY LTD	2009	A.HILL	J. LIM	
				- 1

PAGE L45-A102 LOT 45, 2 CASSYTHA CLOSE

GROUND FLOOR PLAN



Room List	
Room Name	Measured Area
Bath	7.74
BATH	6.02
Bed 1	13.40
Bed 2	13.71
Deck (POS)	24.49
Entry	7.74
Garage	35.76
Kitchen	30.73
LANDING	1.77
L'dry	2.30
Living	31.88
Master	12.77
Subfloor	55.03
WIR	7.79
	251.13 m²

Kingborough Council

Development Application: DA-2024-309 Plan Reference No: P2 Date Received: 13/11/2024

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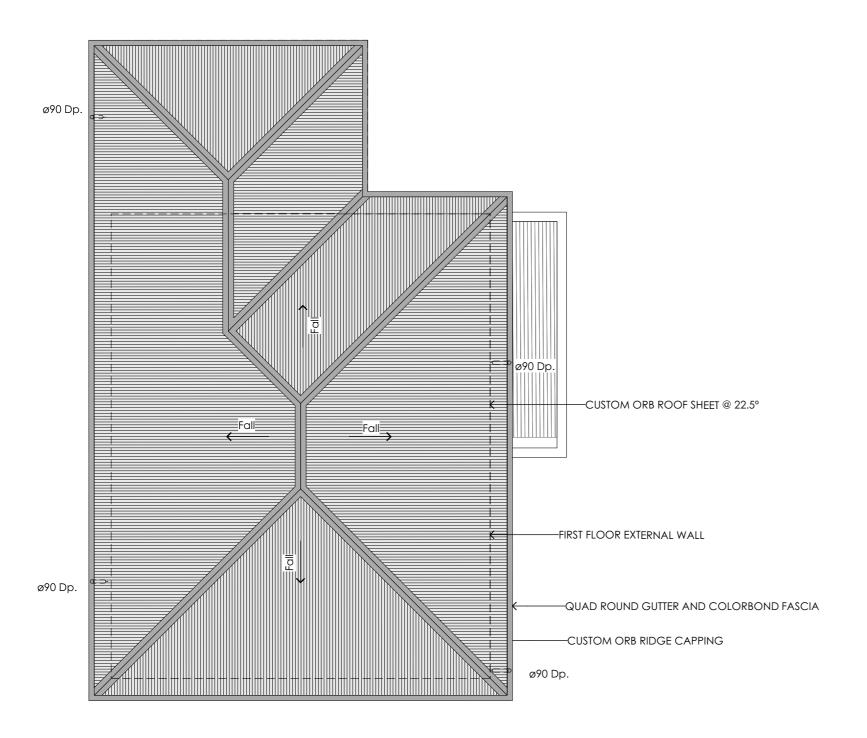
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Description	Date
	Description

PROJECT	REVISION	DATE	SCALE
CASSYTHA CLOSE 4 VILLAGE DRIVE KINGSTON TAS 7050		13/11/2024	AS SHOWN @ A3
CLIENT	PROJECT ID	CHECKED BY	DRAWN BY
MORNING STAR HOLDINGS PTY LTD	2009	A.HILL	J. LIM

PAGE	NORTH
L45-A103 LOT 45, 2 CASSYTHA CLOSE	A A
DRAWING	<u> </u>
FIRST FLOOR PLAN	



Roof Plan @ A3 Scale1:100



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Description

Design Rainfall (100yr 5 min Duration)

Max Catchment Area per Downpipe

Number Downpipes Required

Roof Catchment Area


Downpipe Crossection

Roof Pitch

LEGEND & NOTES

Downpipe 90dia PVC downpipe

1. GUTTERS MUST BE INSTALLED WITH A FALL OF NOT LESS THAN 1:500 FOR EAVES GUTTERS, UNLESS FIXED TO METAL FASCIAS; AND 1:100 FOR

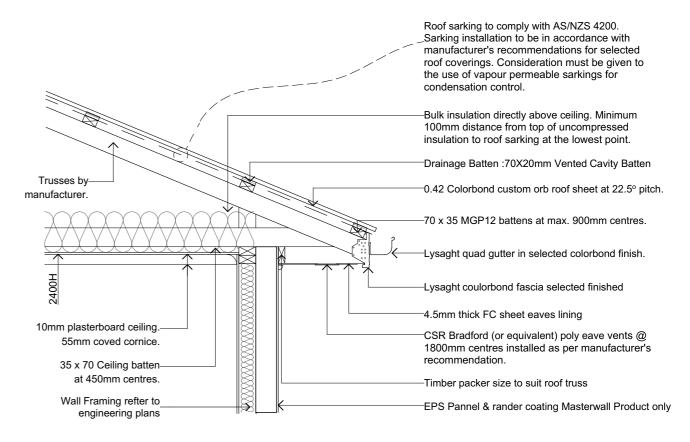

ROOF CONDENSATION CONTROL DETAIL

Kingborough Council

Development Application: DA-2024-309 Plan Reference No: P2 Date Received: 13/11/2024

Date placed on Public Exhibition: 20/11/2024 AS3500.3 - STORMWATER DRAINAGE

116L/s (NCC Vol 2 Part 3.5.2.5)


90dia - 6400 - (TABLE 3.3)


64m2 (FIG 3.5 (A))

Rp / C = 3.70

22.5 deg Rc x 1.21 slope factor = 236.93m2 (TABLE 3.2)

N	umber Downpipes P	rovided	4 (rounded up)		
OJECT	REVISION	DATE	SCALE	PAGE	NORTH
ASSYTHA CLOSE VILLAGE DRIVE KINGSTON TAS 7050		13/11/2024	AS SHOWN @ A3	L45-A104 LOT 45, 2 CASSYTHA CLOSE	\bigcap_{N}
IENT	PROJECT ID	CHECKED BY	DRAWN BY	DRAWING	9
ORNING STAR HOLDINGS PTY LTD	2009	A.HILL	J. LIM	ROOF PLAN	

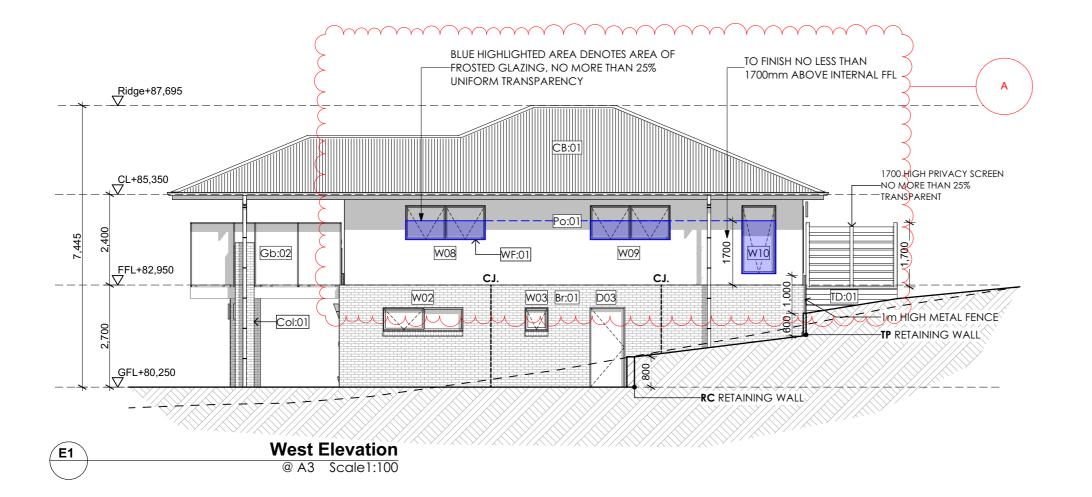

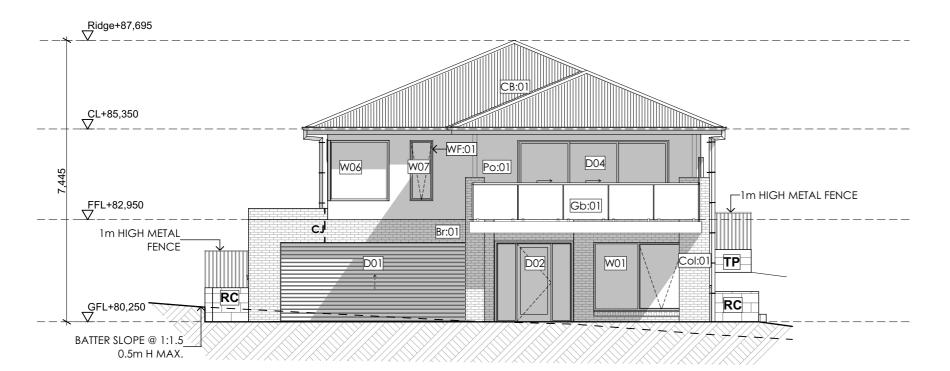

North Elevation @ A3 Scale1:100

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Rev ID	Description	Date
Α	WINDOW PRIVACY	13/11/2024

PROJECT	REVISION	DATE	SCALE
CASSYTHA CLOSE 4 VILLAGE DRIVE KINGSTON TAS 7050	A	13/11/2024	AS SHOWN @ A3
CLIENT	PROJECT ID	CHECKED BY	DRAWN BY
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LEGEND & NOTES

DP. Downpipe

FL. Floor level

CL. Ceiling level

Face brickwork Br:01

CB:01 Colorbond roof

Glass balustrade, min. 1,000mm high to comply with AS1288. 40dia. S/S handrail and verticals, supplied as a complete approved system with toughened glass and securely fixed to perimeter PFC. The complete system must be capable of bearing loading forces according to AS 1170.1

Glass privacy screen min. 1,700mm high to comply with AS1288. 40dia. S/S handrail and verticals, supplied as a complete approved system with toughened glass and securely fixed to perimeter PFC. The complete system must be capable of bearing loading forces according to AS 1170.1 No more than 25% transparency

Powdercoated aluminium window / door frames

Colour: Basalt.

TD:01 Timber framed deck

Easylap cement sheet

Conc:01 Concrete driveway

190 series concrete block retaining wall

Col:01 rendered 100 series block column

TS:01 Timber screen

Fibre cement sheet cladding Render finish FC:01

CJVertical articulation joints as shown or not more than

5m

FE 1m high timber screen

Treated pine retaining wall

RC Reinforced concrete block retaining wall

NGL


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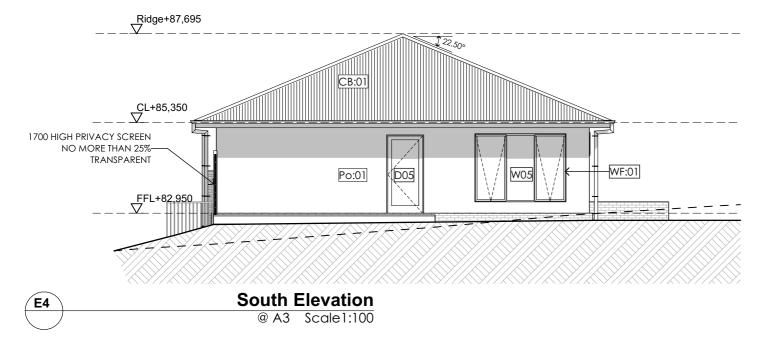
Development Application: DA-2024-309

Plan Reference No: P2 Date Received: 13/11/2024

Date placed on Public Exhibition: 20/11/2024

PAGE	NORTH
L45-A105 LOT 45, 2 CASSYTHA CLOSE	
DRAWING	
ELEVATION 01	



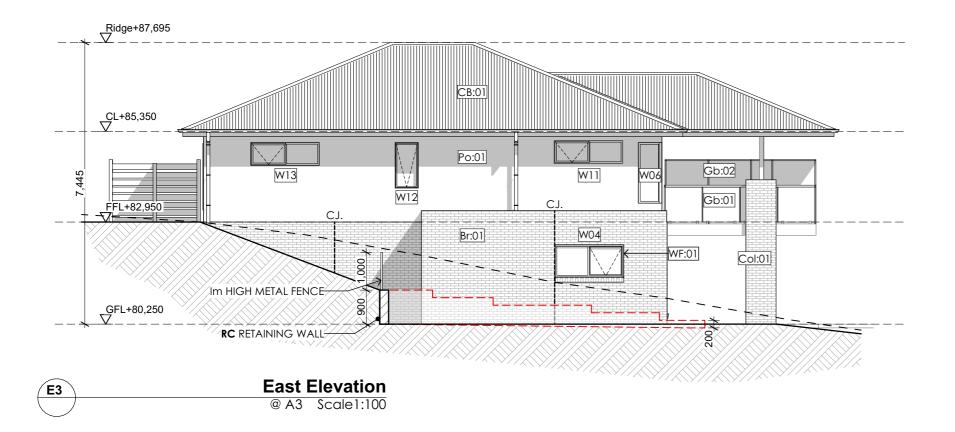

LEGEND & NOTES

DP.	Downpipe		
FL.	Floor level		
CL.	Ceiling level		
Br:01	Face brickwork		
CB:01	Colorbond roof		
GB:01	Glass balustrade, min. 1,000mm high to comply with AS1288. 40dia. S/S handrail and verticals, supplied as a complete approved system with toughened glass and securely fixed to perimeter PFC. The complete system must be capable of bearing loading forces according to AS 1170.1		
GB:02	Glass privacy screen min. 1,700mm high to comply with A\$1288. 40dia. \$/\$ handrail and verticals, supplied as a complete approved system with toughened glass and securely fixed to perimeter PFC. The complete system must be capable of bearing loading forces according to A\$ 1170.1 No more than 25% transparency		
WF:01	Powdercoated aluminium window / door frames Colour: Basalt.		
TD:01	Timber framed deck		
CS:01	Easylap cement sheet		
Conc:0	1 Concrete driveway		
RW:01	190 series concrete block retaining wall		
Col:01	rendered 100 series block column		
TS:01	Timber screen		
FC:01	Fibre cement sheet cladding Render finish		
Cl	Vertical articulation joints as shown or not more than 5m		
	FE 1m high timber screen		
	TP Treated pine retaining wall		

Kingborough Council

RC Reinforced concrete block retaining wall

Development Application: DA-2024-309 Plan Reference No: P2 Date Received: 13/11/2024

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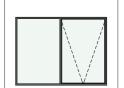
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PROJECT	REVISION	DATE	SCALE
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CLIENT	PROJECT ID	CHECKED BY	DRAWN BY
MORNING STAR HOLDINGS PTY LTD	2009	A.HILL	J. LIM

DRAWING	
LOT 45, 2 CASSYTHA CLOSE	
L45-A106	
PAGE	NORTH

Window Types




























D	W01
V x H Size	2,410×1,800
Sill Height	300
Opening Type	Awing
Blazing	Clear double glaz
rame type	Powdercoated Aluminium

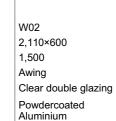

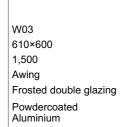

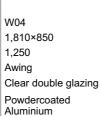

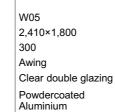

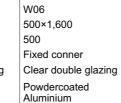

W06 1,500×1,600 500 Fixed conner Clear double glazing Powdercoated Aluminium

W07 600×1,600 500 Fixed conner Powdercoated


Clear double glazing

W08 W09 2.110×900 2.110×900 1,250 1,250 Awing Awing Clear double glazing Clear double glazing Powdercoated Powdercoated Aluminium Aluminium


W10 900×1,800 300 Awing Clear double glazing Powdercoated Aluminium

W11 1,810×600 1,500 Awing Clear double glazing Powdercoated Aluminium


Window Types

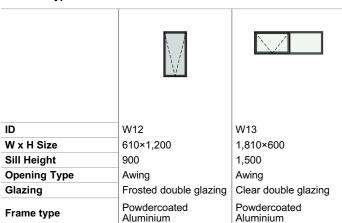




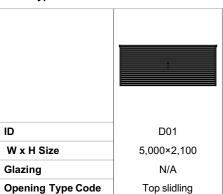




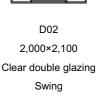


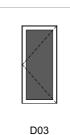

900×2,040 N/A Swing

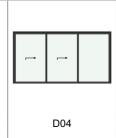

4,000×2,100 Clear double glazing Sliding

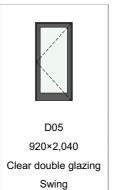

Kingborough Council

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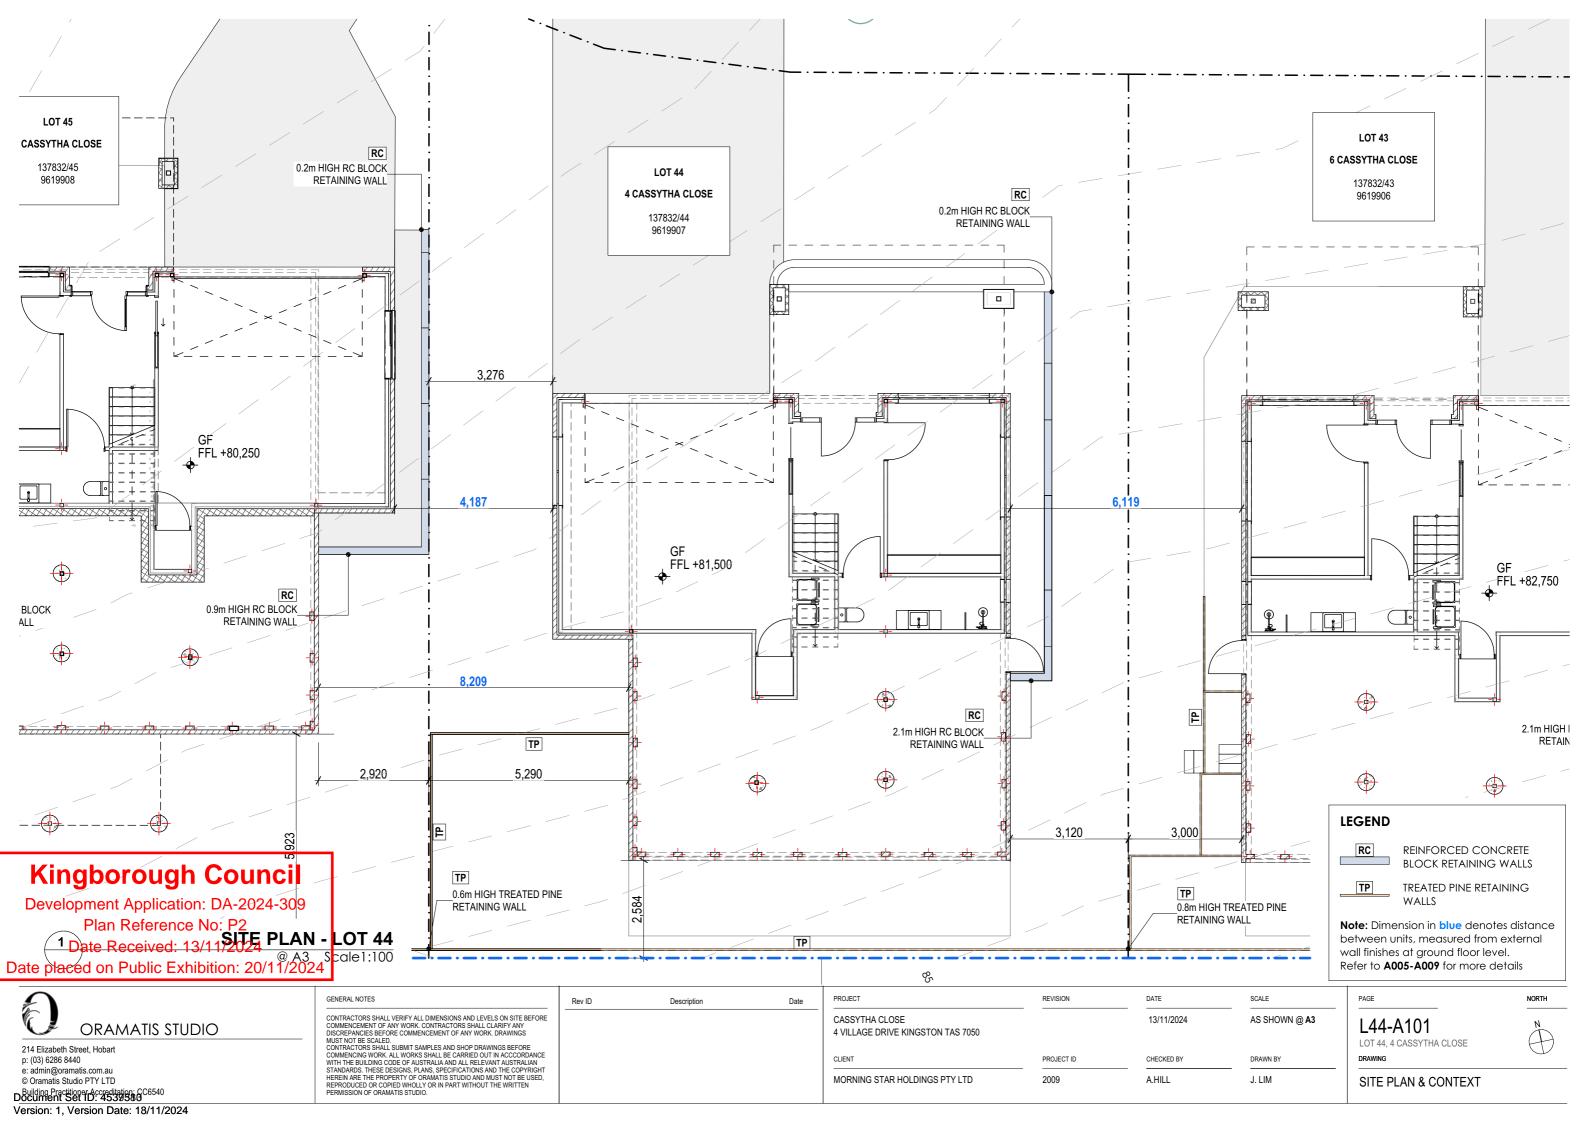
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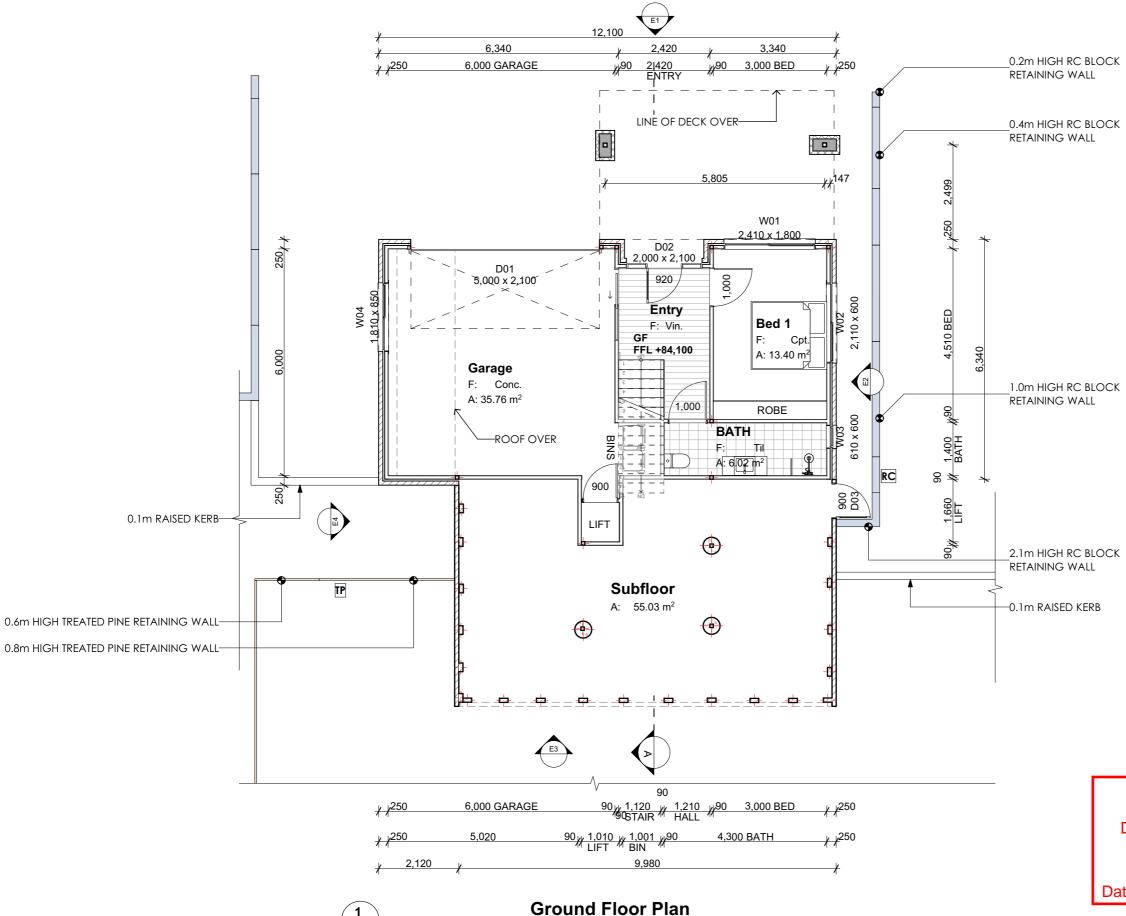
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PROJECT CASSYTHA CLOSE 4 VILLAGE DRIVE KINGSTON TAS 7050 MORNING STAR HOLDINGS PTY LTD

REVISION DATE SCALE 13/11/2024 AS SHOWN @ A3 PROJECT ID CHECKED BY DRAWN BY 2009 A.HILL J. LIM

PAGE NORTH L45-A107 LOT 45, 2 CASSYTHA CLOSE WINDOW & DOOR SCHEDULE





Daniel Manager d'Aug
Room Name Measured Area
Bath 7.74
BATH 6.02
Bed 1 13.40
Bed 2 13.71
Deck 24.43
Entry 7.74
Garage 35.76
Kitchen 30.73
LANDING 1.00
L'dry 2.30
Living 31.88
Master 12.77
Subfloor 55.03
WIR 7.79
250.30 m²

LEGEND

TP TREATED PINE RETAINING WALL REINFORCED CONCRETE BLOCK RETAINING WALL

FE TIMBER FENCE

NOMINAL nom

CONFIRM ON SITE

Kingborough Council

Development Application: DA-2024-309 Plan Reference No: P2 Date Received: 13/11/2024

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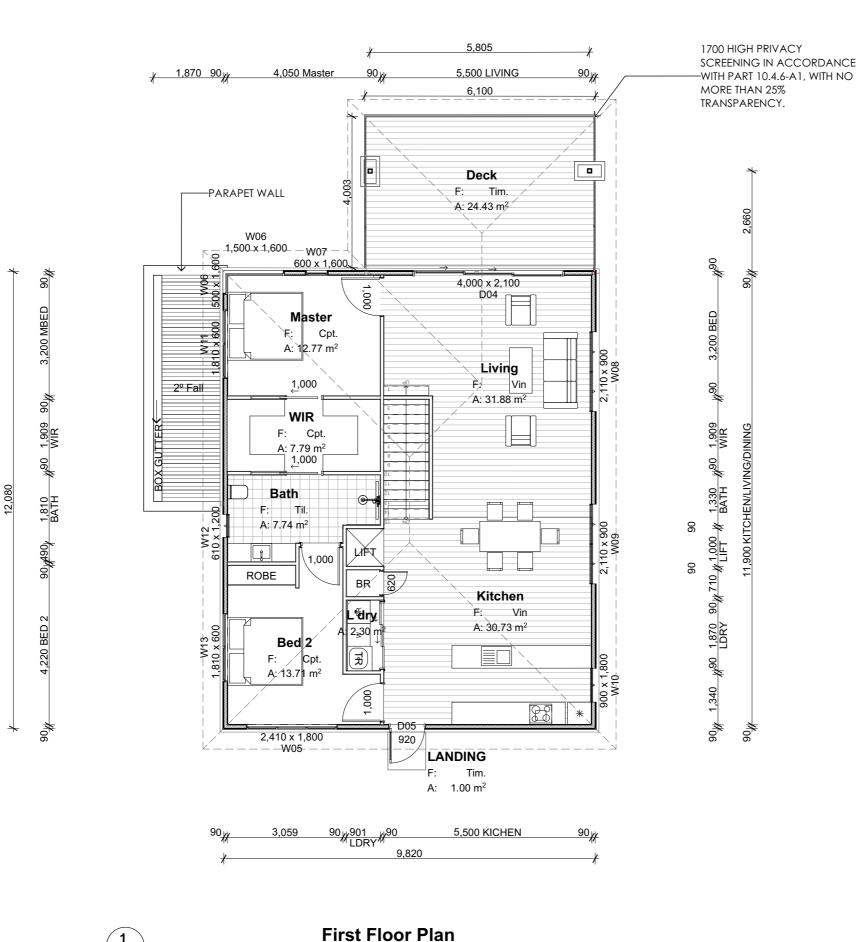
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Rev ID	Description	Date

@ A3 Scale1:100

PROJECT CASSYTHA CLOSE 4 VILLAGE DRIVE KINGSTON TAS 7050	REVISION	DATE 13/11/2024	AS SHOWN @ A3
CLIENT	PROJECT ID	CHECKED BY	DRAWN BY
MORNING STAR HOLDINGS PTY LTD	2009	A.HILL	J. LIM





Room List		
Room Name	Measured Area	
Bath	7.74	
BATH	6.02	
Bed 1	13.40	
Bed 2	13.71	
Deck	24.43	
Entry	7.74	
Garage	35.76	
Kitchen	30.73	
LANDING	1.00	
L'dry	2.30	
Living	31.88	
Master	12.77	
Subfloor	55.03	
WIR	7.79	
	250.30 m²	

Kingborough Council

Development Application: DA-2024-309 Plan Reference No: P2 Date Received: 13/11/2024

Date placed on Public Exhibition: 20/11/2024



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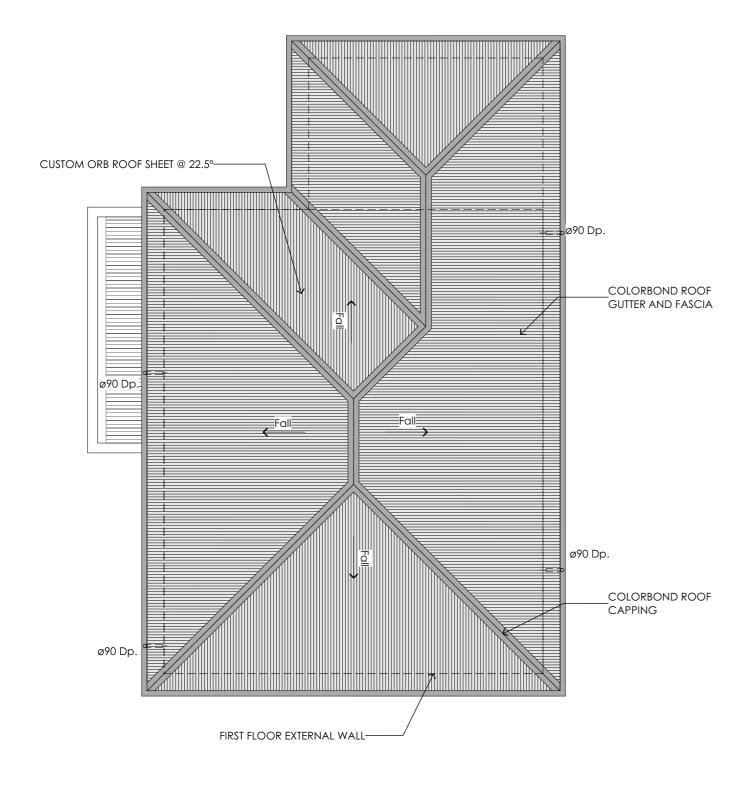
PROJECT	REVISION	DATE	SCALE
CASSYTHA CLOSE 4 VILLAGE DRIVE KINGSTON TAS 7050		13/11/2024	AS SHOWN @ A3
CLIENT	PROJECT ID	CHECKED BY	DRAWN BY
MORNING STAR HOLDINGS PTY LTD	2009	A.HILL	J. LIM

L44-A103

LOT 44, 4 CASSYTHA CLOSE

FIRST FLOOR PLAN

Version: 1, Version Date: 18/11/2024





GENERAL NOTES



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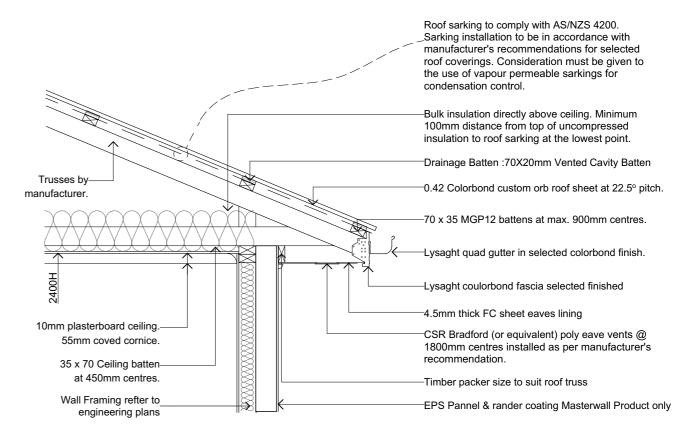
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Description

LEGEND & NOTES

Downpipe 90dia PVC downpipe

1. GUTTERS MUST BE INSTALLED WITH A FALL OF NOT LESS THAN 1:500 FOR EAVES GUTTERS, UNLESS FIXED TO METAL FASCIAS; AND 1:100 FOR



ROOF CONDENSATION CONTROL DETAIL

Kingborough Council

Development Application: DA-2024-309 Plan Reference No: P2 Date Received: 13/11/2024 Date placed on Public Exhibition: 20/11/2024

	AS3500.3 - S	STORMWATER DRAINAGE
Rc	Roof Catchment Area	195.81m2
	Roof Pitch	22.5 deg Rc x 1.21 slope factor = 236.93m2 (TABLE 3.2)
	Design Rainfall (100yr 5 min Duration)	116L/s (NCC Vol 2 Part 3.5.2.5)
	Downpipe Crossection	90dia - 6400 - (TABLE 3.3)
С	Max Catchment Area per Downpipe	64m2 (FIG 3.5 (A))
	Number Downpipes Required	Rp / C = 3.70
	Number Downpipes Provided	4 (rounded up)


PROJECT	REVISION	DATE	SCALE
CASSYTHA CLOSE 4 VILLAGE DRIVE KINGSTON TAS 7050		13/11/2024	AS SHOWN @ A3
CLIENT	PROJECT ID	CHECKED BY	DRAWN BY
MORNING STAR HOLDINGS PTY LTD	2009	A.HILL	J. LIM



ROOF PLAN



NORTH ELEVATION E1 @ A3 Scale1:100

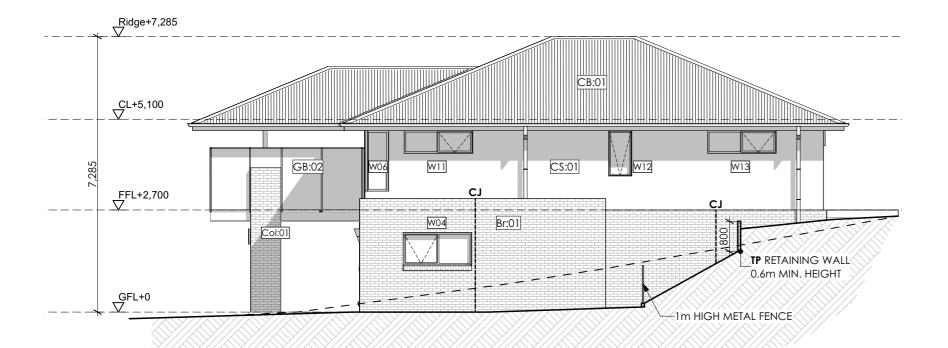

WEST ELEVATION @ A3 Scale1:100

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Description

PROJECT REVISION DATE SCALE AS SHOWN @ A3 CASSYTHA CLOSE 13/11/2024 4 VILLAGE DRIVE KINGSTON TAS 7050 PROJECT ID CHECKED BY DRAWN BY MORNING STAR HOLDINGS PTY LTD 2009 A.HILL J. LIM

LEGEND & NOTES

DP. Downpipe

FL. Floor level

CL. Ceiling level

Face brickwork Br:01

CB:01 Colorbond roof

Glass balustrade, min. 1,000mm high to comply with AS1288. 40dia. S/S handrail and verticals, supplied as a complete approved system with toughened glass and securely fixed to perimeter PFC. The complete system must be capable of bearing loading forces according to AS 1170.1

Glass privacy screen min. 1,700mm high to comply with AS1288. 40dia. S/S handrail and verticals, supplied as a complete approved system with toughened glass and securely fixed to perimeter PFC. The complete system must be capable of bearing loading forces according to AS 1170.1 No more than 25% transparency

Powdercoated aluminium window / door frames

Colour: Basalt.

TD:01 Timber framed deck

Easylap cement sheet

Conc:01 Concrete driveway

190 series concrete block retaining wall

Col:01 rendered 100 series block column

TS:01 Timber screen

Fibre cement sheet cladding Render finish FC:01

CJVertical articulation joints as shown or not more than 5m

FE 1m high timber screen

Treated pine retaining wall

RC Reinforced concrete block retaining wall


NGL

Kingborough Council


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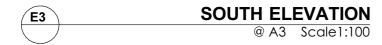
Date placed on Public Exhibition: 20/11/2024





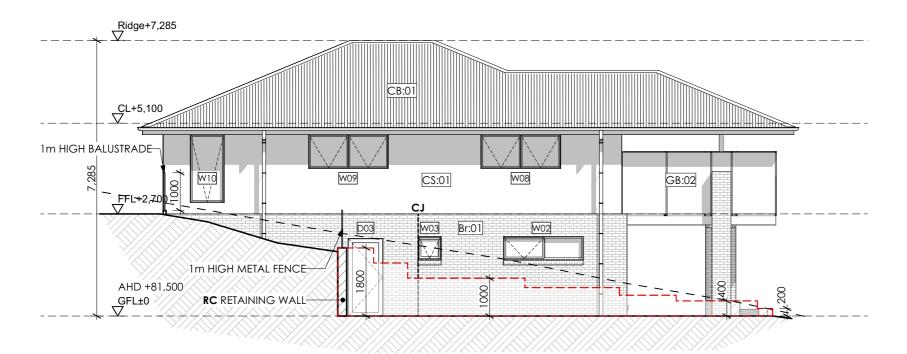



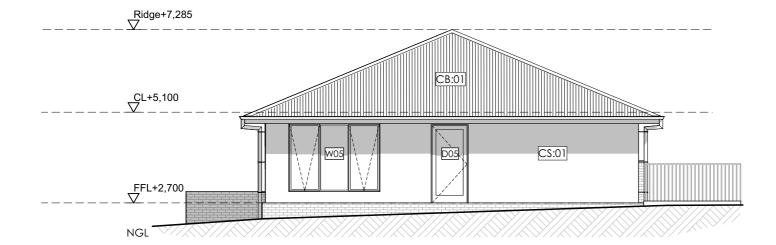

LEGEND & NOTES

DP. Downpipe

FL. Floor level

CL. Ceiling level

Face brickwork Br:01

CB:01 Colorbond roof

Glass balustrade, min. 1,000mm high to comply with AS1288. 40dia. S/S handrail and verticals, supplied as a complete approved system with toughened glass and securely fixed to perimeter PFC. The complete system must be capable of bearing loading forces according to AS 1170.1

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Powdercoated aluminium window / door frames

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TD:01 Timber framed deck

Easylap cement sheet

Conc:01 Concrete driveway

190 series concrete block retaining wall

Col:01 rendered 100 series block column

TS:01 Timber screen

FC:01 Fibre cement sheet cladding Render finish

Vertical articulation joints as shown or not more than CJ

FE 1m high timber screen

TP Treated pine retaining wall

RC Reinforced concrete block retaining wall

--- NGL

Kingborough Council

Development Application: DA-2024-309 Plan Reference No: P2

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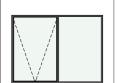
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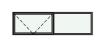
Rev ID	Description	Date

PROJECT	REVISION	DATE	SCALE
CASSYTHA CLOSE 4 VILLAGE DRIVE KINGSTON TAS 7050		13/11/2024	AS SHOWN @ A3
CLIENT	PROJECT ID	CHECKED BY	DRAWN BY
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L44-A106	
LOT 44, 4 CASSYTHA CLOSE	
DRAWING	


Window Types









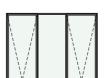













ID W01 W x H Size 2,410×1,800 300 Sill Height Awing Opening Type Glazing Clear double glazing Powdercoated Frame type Aluminium

W02 2.110×600 1,500 Awing Clear double glazing Powdercoated Aluminium

W03 610×600 1,500 Awing Frosted double glazing Powdercoated Aluminium

W04 1,810×850 1,250 Awing Clear double glazing Powdercoated Aluminium

W05 2,410×1,800 300 Awing Clear double glazing Powdercoated Aluminium

W06 500×1,600 500 Fixed conner Powdercoated Aluminium

W06 1,500×1,600 500 Fixed conner Clear double glazing Clear double glazing Powdercoated Aluminium

600×1,600 500 Fixed conner Powdercoated Aluminium

W07 Clear double glazing

W08 2.110×900 1,200 Awing Clear double glazing

1,200 Awing Clear double glazing Powdercoated Powdercoated Aluminium Aluminium

W09


2.110×900

W10 900×1,800 300 Awing Clear double glazing Powdercoated


Aluminium

W11 1,810×600 1,500 Awing Clear double glazing Powdercoated Aluminium

Window Types

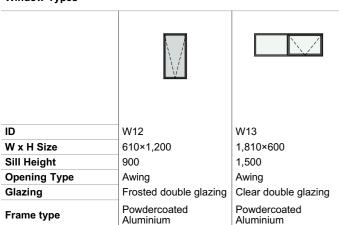



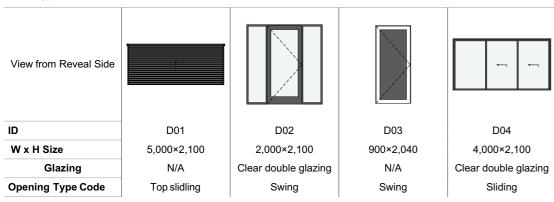

Kingborough Council

Development Application: DA-2024-309 Plan Reference No: P2 Date Received: 13/11/2024

Date placed on Public Exhibition: 20/11/2024

NOTE:

*BUILT AS APPROVED UNDER **DA-2021-215**



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D05


920×2,040


Clear double glazing

Swing

PROJECT	REVISION	DATE	SCALE
CASSYTHA CLOSE 4 VILLAGE DRIVE KINGSTON TAS 7050		13/11/2024	AS SHOWN @ A3
CLIENT	PROJECT ID	CHECKED BY	DRAWN BY
MORNING STAR HOLDINGS PTY LTD	2009	A.HILL	J. LIM

PAGE	NORTH
L44-A107 LOT 44, 4 CASSYTHA CLOSE	
DRAWING	

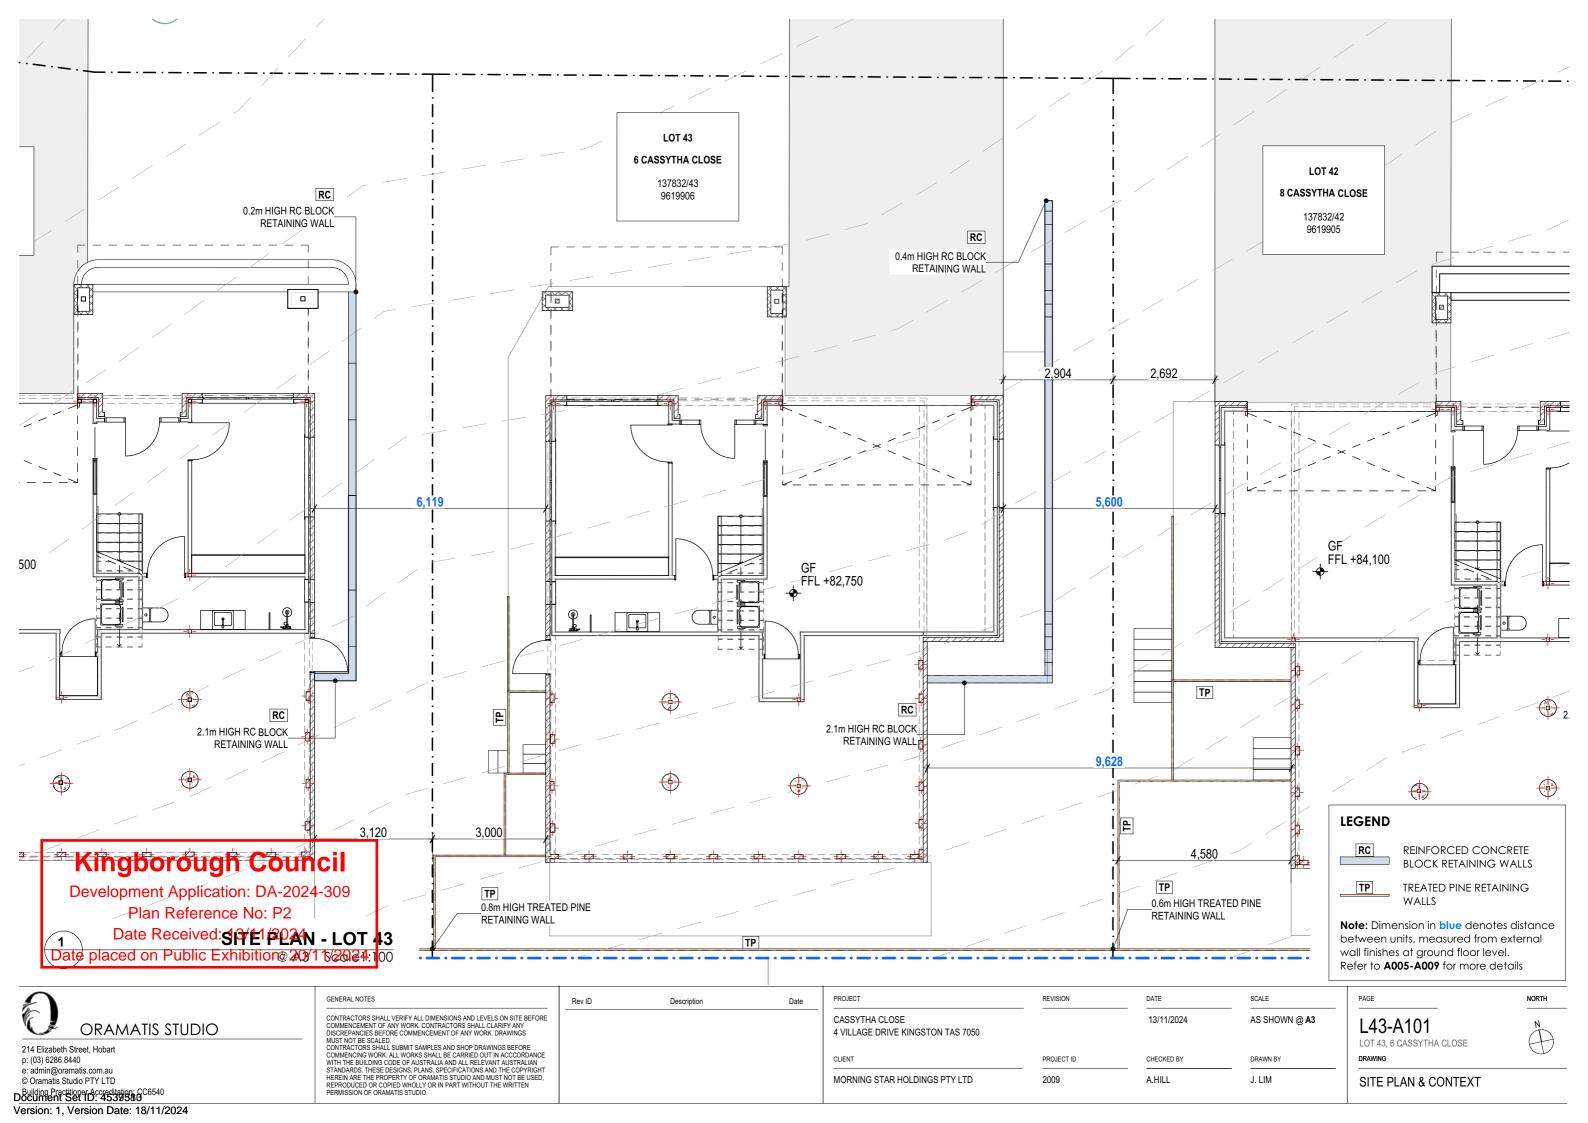

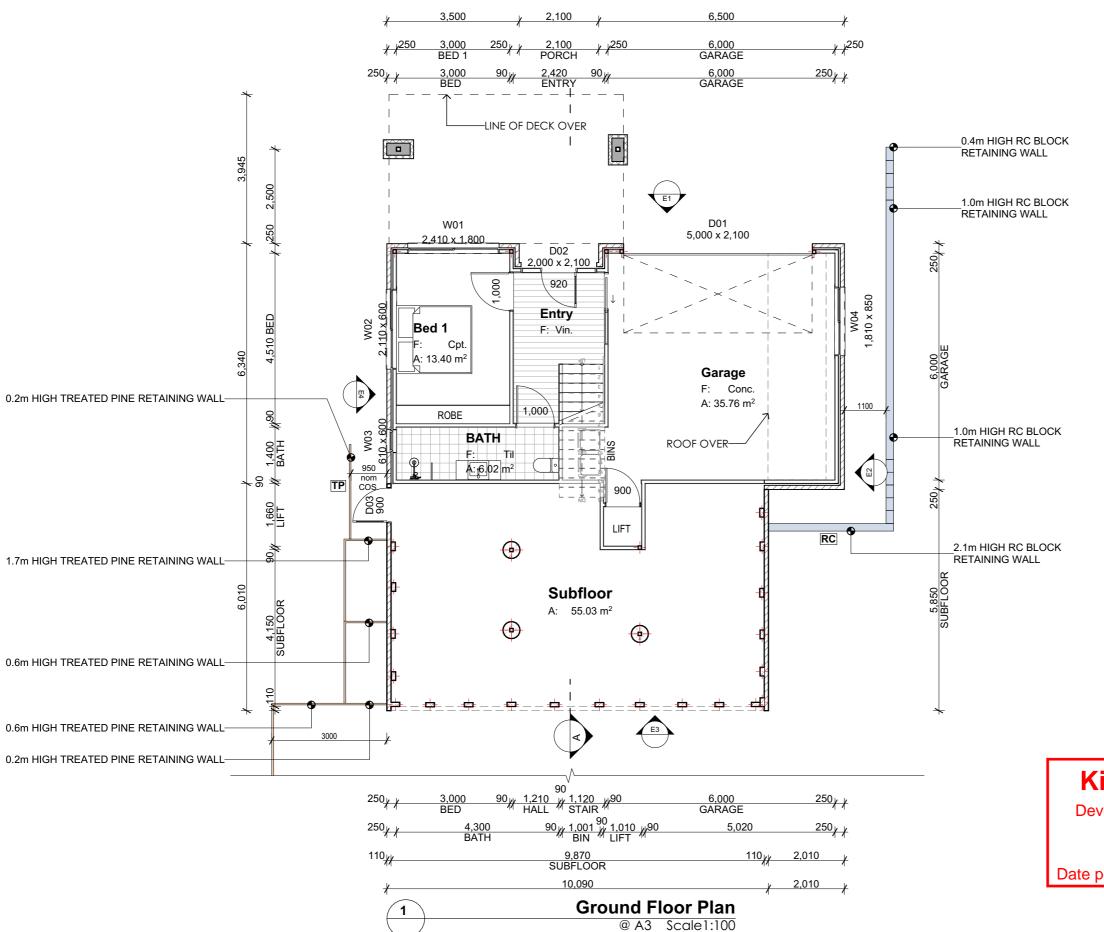

Room List		
Room Name	Measured Area	
Bath	7.74	
BATH	6.02	
Bed 1	13.40	
Bed 2	13.71	
Deck (POS)	24.49	
Entry	7.74	
Garage	35.76	
Kitchen	30.73	
ANDING	1.77	
L'dry	2.30	
Living	31.88	
Master	12.77	
Subfloor	55.03	
WIR	7.79	
	251.13 m²	

LEGEND

TREATED PINE RETAINING WALL



REINFORCED CONCRETE **BLOCK RETAINING WALL**

FE

TIMBER FENCE

CONFIRM ON SITE

NOMINAL nom

Kingborough Council

Development Application: DA-2024-309 Plan Reference No: P2 Date Received: 13/11/2024

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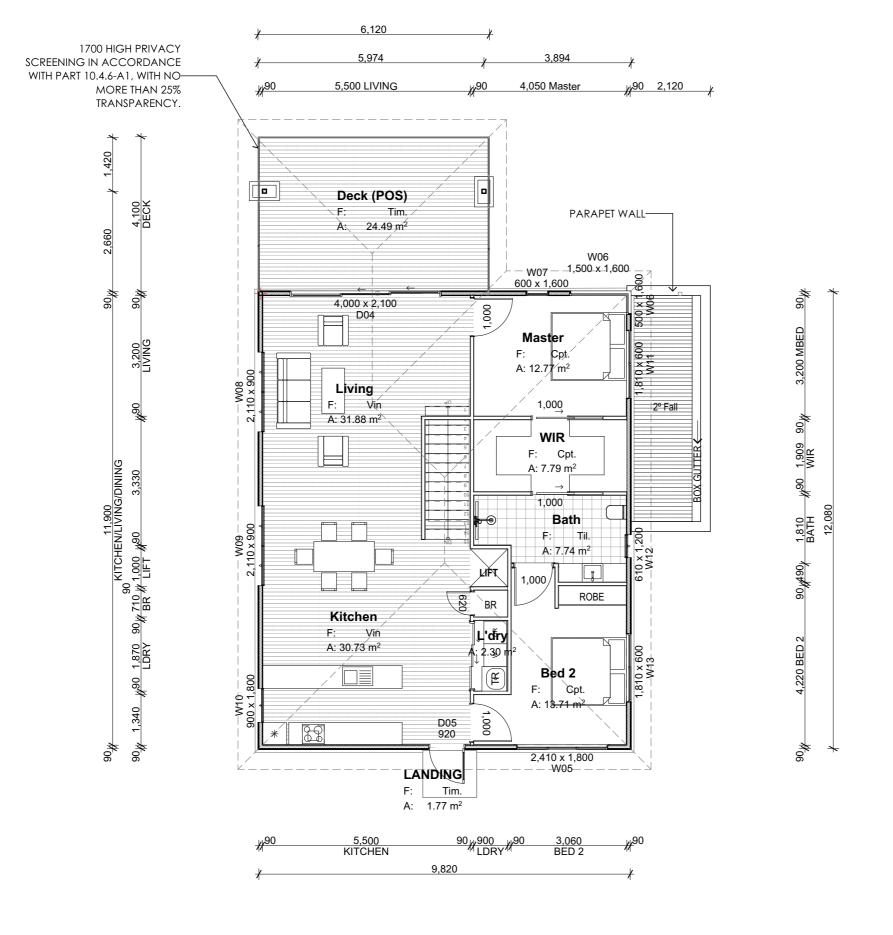
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Rev ID	Description	Date

PROJECT	REVISION	DATE	SCALE	Р
CASSYTHA CLOSE 4 VILLAGE DRIVE KINGSTON TAS 7050		13/11/2024	AS SHOWN @ A3	
CLIENT	PROJECT ID	CHECKED BY	DRAWN BY	D
MORNING STAR HOLDINGS PTY LTD	2009	A.HILL	J. LIM	(

L43-A102 LOT 43, 6 CASSYTHA CLOSE

GROUND FLOOR PLAN



Room List		
Room Name	Measured Area	
Bath	7.74	
BATH	6.02	
Bed 1	13.40	
Bed 2	13.71	
Deck (POS)	24.49	
Entry	7.74	
Garage	35.76	
Kitchen	30.73	
LANDING	1.77	
L'dry	2.30	
Living	31.88	
Master	12.77	
Subfloor	55.03	
WIR	7.79	
	251.13 m²	

Kingborough Council

Development Application: DA-2024-309 Plan Reference No: P2 Date Received: 13/11/2024

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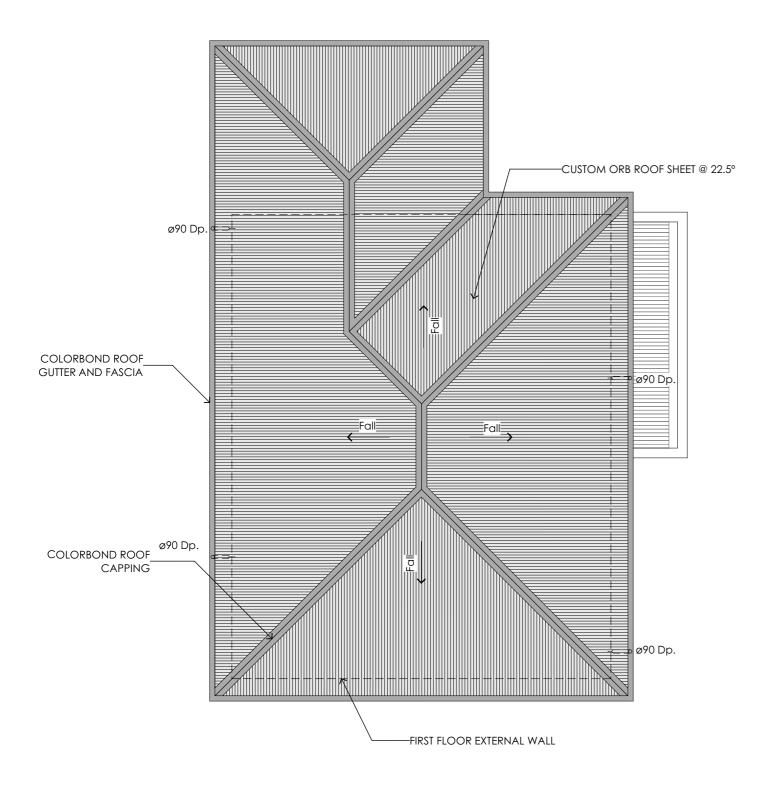
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CLIENT	PROJECT ID	CHECKED BY	DRAWN BY
MORNING STAR HOLDINGS PTY LTD	2009	A.HILL	J. LIM

PAGE	NORTH
L43-A103 LOT 43, 6 CASSYTHA CLOSE	N
DRAWING	
FIRST FLOOR PLAN	

Version: 1, Version Date: 18/11/2024





GENERAL NOTES



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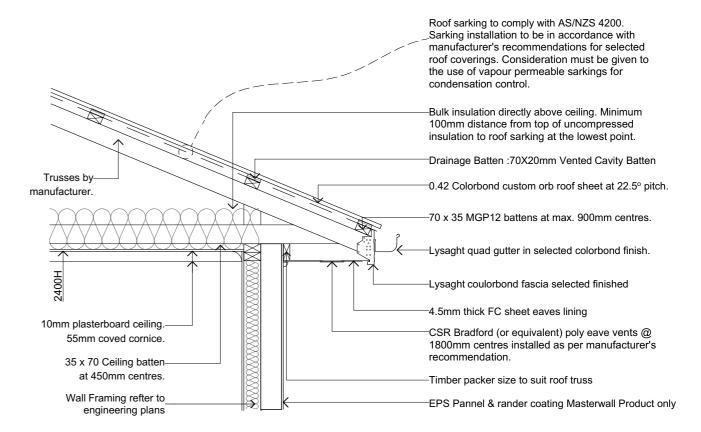
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Description

LEGEND & NOTES

Downpipe 90dia PVC downpipe

1. GUTTERS MUST BE INSTALLED WITH A FALL OF NOT LESS THAN 1:500 FOR EAVES GUTTERS, UNLESS FIXED TO METAL FASCIAS; AND 1:100 FOR



ROOF CONDENSATION CONTROL DETAIL

Kingborough Council

Development Application: DA-2024-309 Plan Reference No: P2 Date Received: 13/11/2024


Date placed on Public Exhibition: 20/11/2024

		•	
	_		
	AS3500.3 - S	STORMWATER DRAINAGE	
_	2 (2)	405.04	
Rc	Roof Catchment Area	195.81m2	
	Roof Pitch	22.5 deg Rc x 1.21 slope factor = 236.93m2 (TABLE 3.2)	
	Design Rainfall (100yr 5 min Duration)	116L/s (NCC Vol 2 Part 3.5.2.5)	
	Downpipe Crossection	90dia - 6400 - (TABLE 3.3)	
С	Max Catchment Area per Downpipe	64m2 (FIG 3.5 (A))	
	Number Downpipes Required	Rp / C = 3.70	
	Number Downpipes Provided	4 (rounded up)	


PROJECT	REVISION	DATE	SCALE
CASSYTHA CLOSE 4 VILLAGE DRIVE KINGSTON TAS 7050		13/11/2024	AS SHOWN @ A3
CLIENT	PROJECT ID	CHECKED BY	DRAWN BY
MORNING STAR HOLDINGS PTY LTD	2009	A.HILL	J. LIM



ROOF PLAN

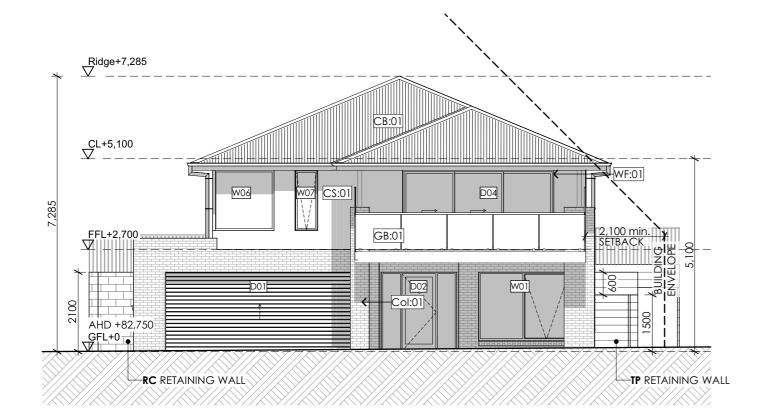



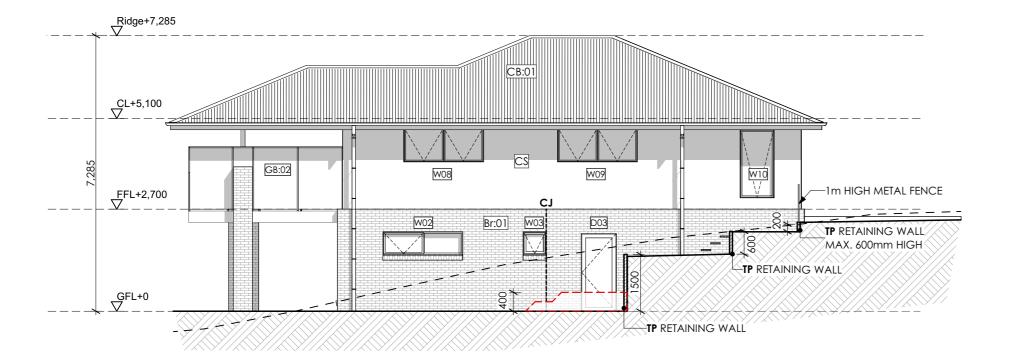

WEST ELEVATION E4 @ A3 Scale1:100

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Date	PROJECT
	CASSYTHA CLOSE 4 VILLAGE DRIVE KINGSTON TAS 7050
	CLIENT
	MORNING STAR HOLDINGS PTY LTD

Description

JECT REVISION DATE SSYTHA CLOSE 13/11/2024 ILLAGE DRIVE KINGSTON TAS 7050 PROJECT ID CHECKED BY

2009

L43-A105 LOT 43, 6 CASSYTHA CLOSE **ELEVATION 01**

LEGEND & NOTES

DP. Downpipe

FL. Floor level

CL. Ceiling level

Face brickwork Br:01

CB:01 Colorbond roof

> Glass balustrade, min. 1,000mm high to comply with AS1288. 40dia. S/S handrail and verticals, supplied as a complete approved system with toughened glass and securely fixed to perimeter PFC. The complete system must be capable of bearing loading forces according to AS 1170.1

Glass privacy screen min. 1,700mm high to comply with AS1288. 40dia. S/S handrail and verticals, supplied as a complete approved system with toughened glass and securely fixed to perimeter PFC. The complete system must be capable of bearing loading forces according to AS 1170.1 No more than 25% transparency

Powdercoated aluminium window / door frames

Colour: Basalt.

TD:01 Timber framed deck

Easylap cement sheet

Conc:01 Concrete driveway

190 series concrete block retaining wall

Col:01 rendered 100 series block column

TS:01 Timber screen

Fibre cement sheet cladding Render finish FC:01

CJVertical articulation joints as shown or not more than

5m

FE 1m high timber screen

Treated pine retaining wall

RC Reinforced concrete block retaining wall

AS SHOWN @ A3

DRAWN BY

J. LIM

NGL

FGL

A.HILL


Kingborough Council

Development Application: DA-2024-309 Plan Reference No: P2


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Date placed on Public Exhibition: 20/11/2024

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SOUTH ELEVATION @ A3 Scale1:100

Kingborough Council

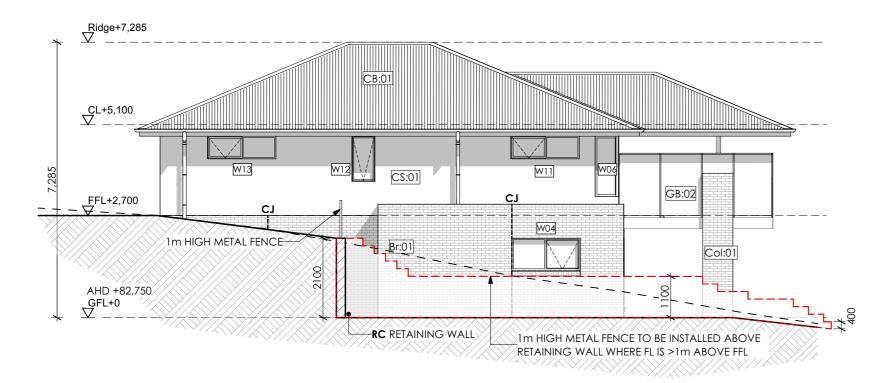Development Application: DA-2024-309 Plan Reference No: P2 Date Received: 13/11/2024

Date placed on Public Exhibition: 20/11/2024

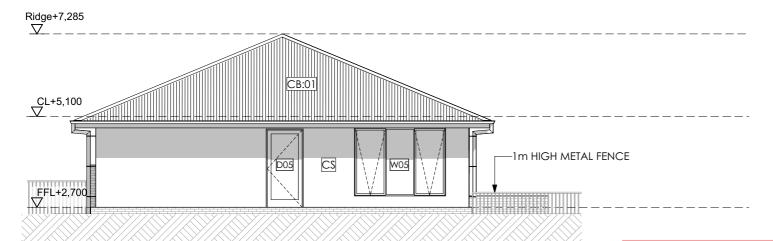LEGEND & NOTES

DP. Downpipe FL. Floor level

CL. Ceiling level

Face brickwork Br:01

CB:01 Colorbond roof

Glass balustrade, min. 1,000mm high to comply with AS1288. 40dia. S/S handrail and verticals, supplied as a complete approved system with toughened glass and securely fixed to perimeter PFC. The complete system must be capable of bearing loading forces according to AS 1170.1

Glass privacy screen min. 1,700mm high to comply with AS1288. 40dia. S/S handrail and verticals, supplied as a complete approved system with toughened glass and securely fixed to perimeter PFC. The complete system must be capable of bearing loading forces according to AS 1170.1 No more than 25% transparency

Powdercoated aluminium window / door frames

Colour: Basalt.

TD:01 Timber framed deck

Easylap cement sheet

Conc:01 Concrete driveway

190 series concrete block retaining wall

Col:01 rendered 100 series block column

TS:01 Timber screen

Fibre cement sheet cladding Render finish

CJVertical articulation joints as shown or not more than

FE 1m high timber screen

Treated pine retaining wall

RC Reinforced concrete block retaining wall

NGL

FGL

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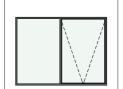
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Rev ID	Description	Date

PROJECT	REVISION	DATE	SCALE
CASSYTHA CLOSE 4 VILLAGE DRIVE KINGSTON TAS 7050		13/11/2024	AS SHOWN @ A3
CLIENT	PROJECT ID	CHECKED BY	DRAWN BY
MORNING STAR HOLDINGS PTY LTD	2009	A.HILL	J. LIM


PAGE		NORTH
LOT	43-A106 43, 6 CASSYTHA CLOSE	
ELI	EVATION 02	

Window Types







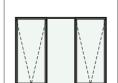


















ID	W01
W x H Size	2,410×1,800
Sill Height	300
Opening Type	Awing
Glazing	Clear double gla
Frame type	Powdercoated Aluminium

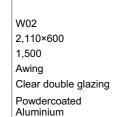

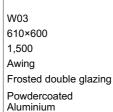

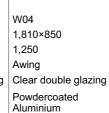

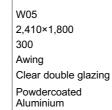

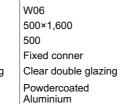


W06 W07 1,500×1,600 500 Fixed conner Clear double glazing Powdercoated Aluminium

600×1,600 500 Fixed conner Clear double glazing Powdercoated Aluminium


W08 2.110×900 1,250 Awing Clear double glazing Powdercoated Aluminium

W09 2.110×900 1,250 Awing Clear double glazing Powdercoated Aluminium


W10 900×1,800 300 Awing Clear double glazing Powdercoated Aluminium

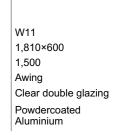


Window Types

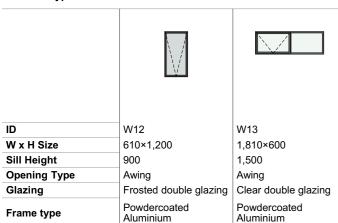




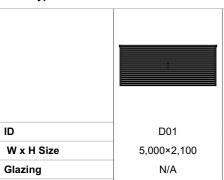




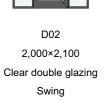


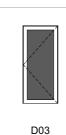

900×2,040 N/A Swing

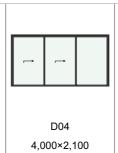

Clear double glazing Sliding

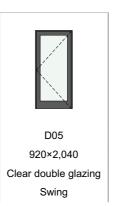

Kingborough Council

Development Application: DA-2024-309 Plan Reference No: P2 Date Received: 13/11/2024

Date placed on Public Exhibition: 20/11/2024

Opening Type Code

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Top slidling

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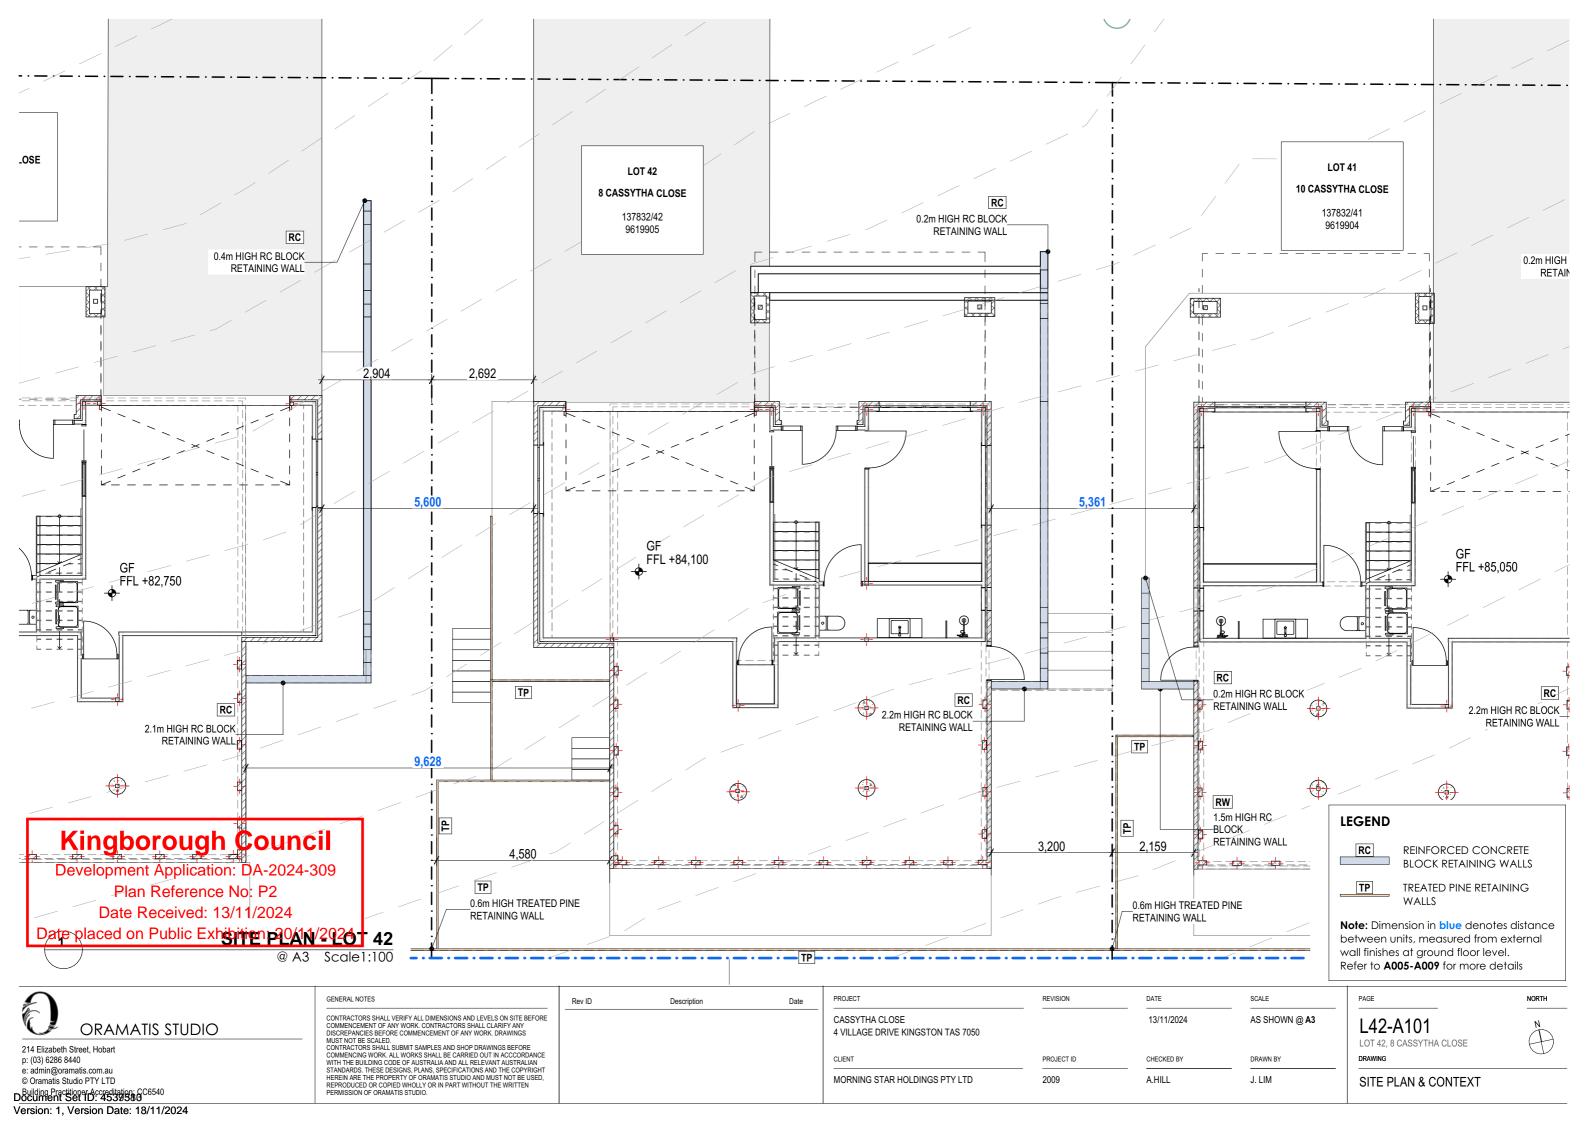
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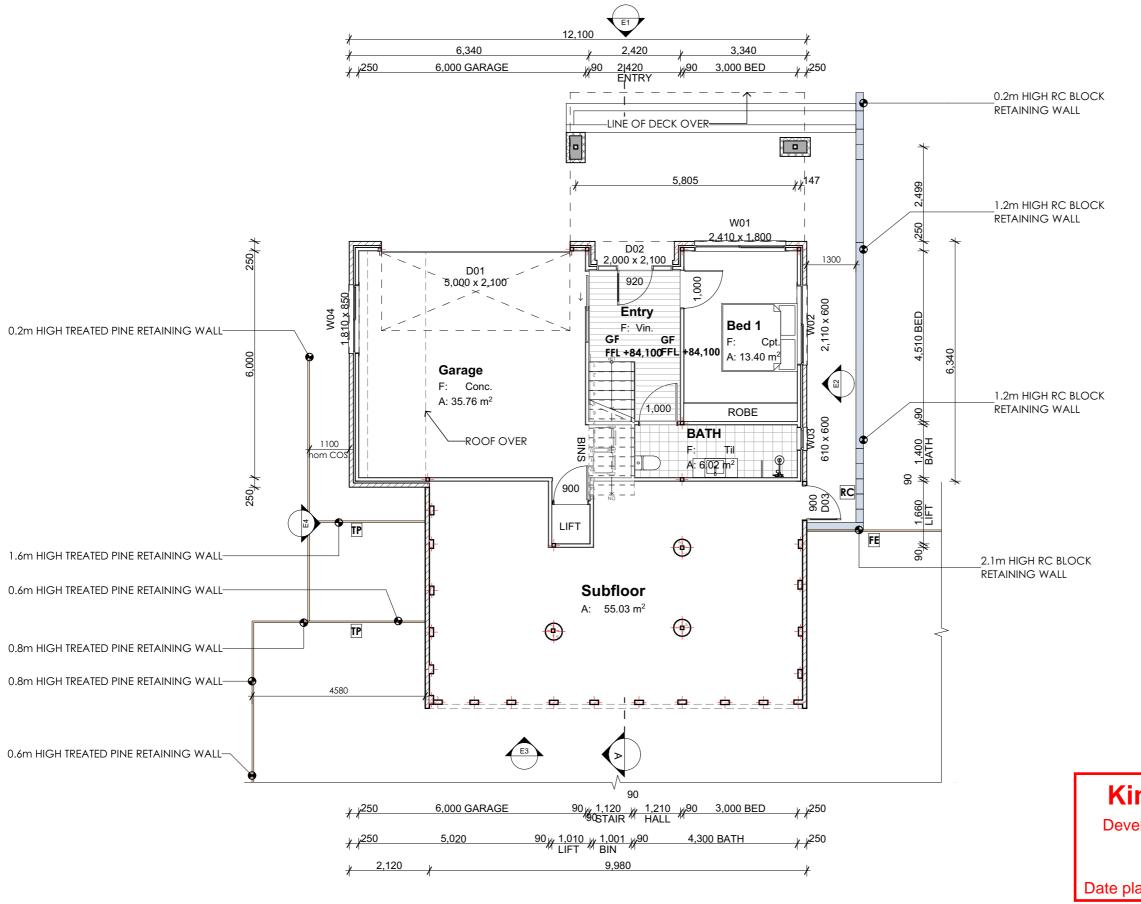
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Rev ID	Description	Date

PROJECT	REVISION	DATE	SCALE
CASSYTHA CLOSE 4 VILLAGE DRIVE KINGSTON TAS 7050		13/11/2024	AS SHOWN @ A
CLIENT	PROJECT ID	CHECKED BY	DRAWN BY
MORNING STAR HOLDINGS PTY LTD	2009	A.HILL	J. LIM

PAGE	NORTH
L43-A107 LOT 43, 6 CASSYTHA CLOSE	
DRAWING	





Room List	
Room Name	Measured Area
Bath	7.74
BATH	6.02
Bed 1	13.40
Bed 2	13.71
Deck	24.43
Entry	7.74
Garage	35.76
Kitchen	30.73
LANDING	1.00
L'dry	2.30
Living	31.88
Master	12.77
Subfloor	55.03
WIR	7.79
	250.30 m²

LEGEND

TREATED PINE RETAINING WALL



REINFORCED CONCRETE BLOCK RETAINING WALL

FE

TIMBER FENCE

NOMINAL nom

CONFIRM ON SITE

Kingborough Council

Development Application: DA-2024-309 Plan Reference No: P2 Date Received: 13/11/2024

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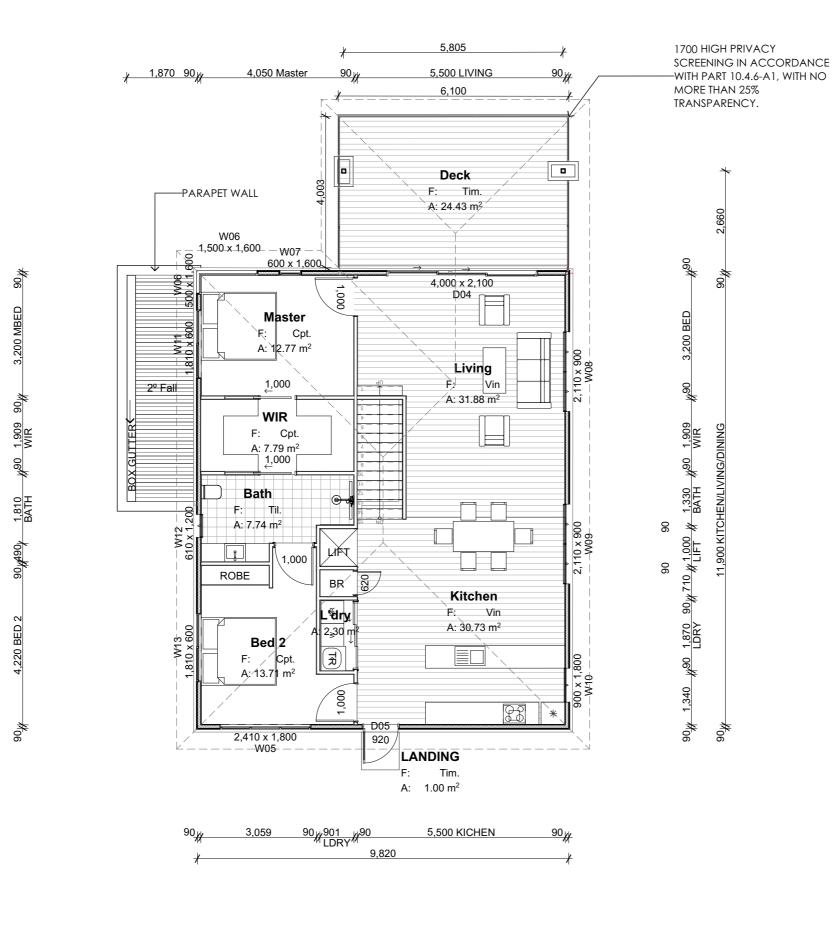
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Rev ID	Description	Date

PROJECT	REVISION	DATE	SCALE	
CASSYTHA CLOSE 4 VILLAGE DRIVE KINGSTON TAS 7050		13/11/2024	AS SHOWN @ A3	
CLIENT	PROJECT ID	CHECKED BY	DRAWN BY	
MORNING STAR HOLDINGS PTY LTD	2009	A.HILL	J. LIM	

PAGE	NORTH
L42-A102 LOT 42, 8 CASSYTHA CLOSE	Ň
DRAWING	Q
GROUND FLOOR PLAN	

Document Set ID: 4539580 Version: 1, Version Date: 18/11/2024



Room List	
Room Name	Measured Area
Bath	7.74
BATH	6.02
Bed 1	13.40
Bed 2	13.71
Deck	24.43
Entry	7.74
Garage	35.76
Kitchen	30.73
LANDING	1.00
L'dry	2.30
Living	31.88
Master	12.77
Subfloor	55.03
WIR	7.79
	250.30 m²

Kingborough Council

Development Application: DA-2024-309 Plan Reference No: P2

Date Received: 13/11/2024

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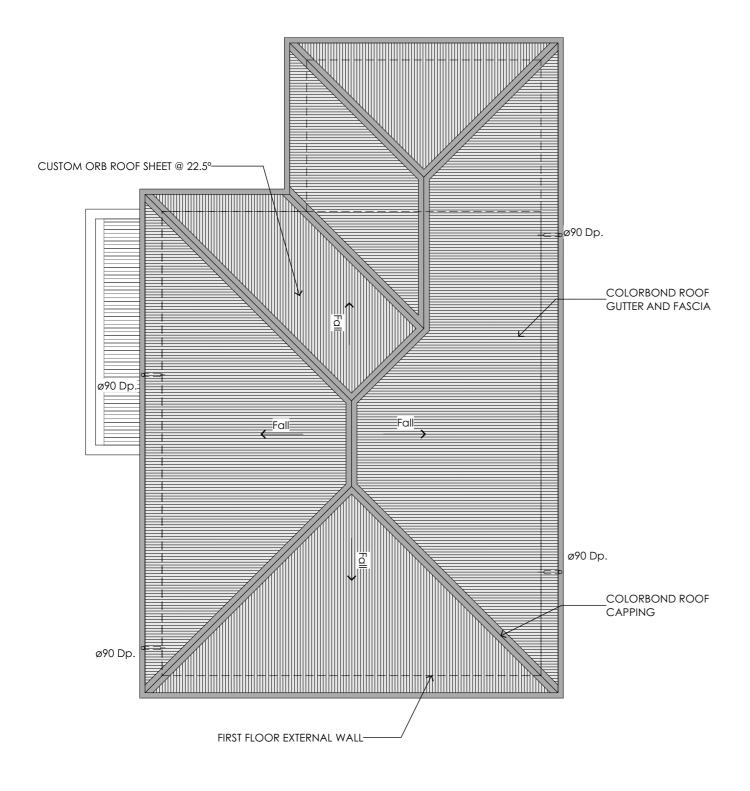
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PROJECT	REVISION	DATE	SCALE
CASSYTHA CLOSE 4 VILLAGE DRIVE KINGSTON TAS 7050		13/11/2024	AS SHOWN @ A3
CLIENT	PROJECT ID	CHECKED BY	DRAWN BY
MORNING STAR HOLDINGS PTY LTD	2009	A.HILL	J. LIM
MORNING STAR HOLDINGS PTY LTD	2009	A.HILL	J. LIM

PAGE L42-A103 LOT 42, 8 CASSYTHA CLOSE FIRST FLOOR PLAN

Version: 1, Version Date: 18/11/2024





GENERAL NOTES



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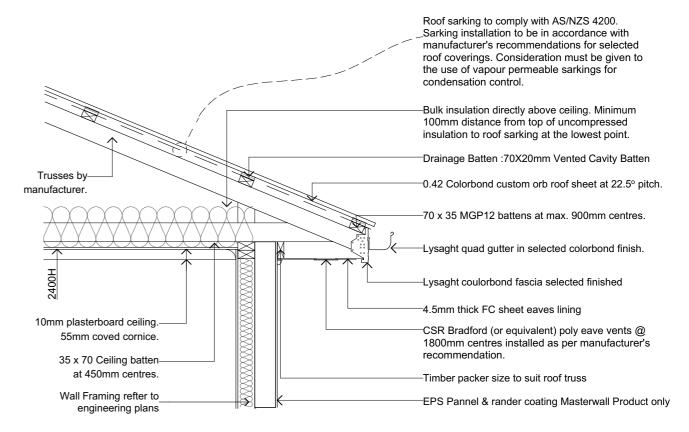
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Date Description

LEGEND & NOTES

Downpipe 90dia PVC downpipe

1. GUTTERS MUST BE INSTALLED WITH A FALL OF NOT LESS THAN 1:500 FOR EAVES GUTTERS, UNLESS FIXED TO METAL FASCIAS; AND 1:100 FOR



ROOF CONDENSATION CONTROL DETAIL

Kingborough Council

Development Application: DA-2024-309 Plan Reference No: P2 Date Received: 13/11/2024


Date placed on Public Exhibition: 20/11/2024

	AS3500.3 - S	STORMWATER DRAINAGE
Rc	Roof Catchment Area	195.81m2
	Roof Pitch	22.5 deg Rc x 1.21 slope factor = 236.93m2 (TABLE 3.2)
	Design Rainfall (100yr 5 min Duration)	116L/s (NCC Vol 2 Part 3.5.2.5)
	Downpipe Crossection	90dia - 6400 - (TABLE 3.3)
С	Max Catchment Area per Downpipe	64m2 (FIG 3.5 (A))
	Number Downpipes Required	Rp / C = 3.70
	Number Downpipes Provided	4 (rounded up)

PROJECT CASSYTHA CLOSE 4 VILLAGE DRIVE KINGSTON TAS 7050	REVISION	DATE 	SCALE AS SHOWN @ A3
CLIENT	PROJECT ID	CHECKED BY	DRAWN BY
MORNING STAR HOLDINGS PTY LTD	2009	A.HILL	J. LIM




ROOF PLAN

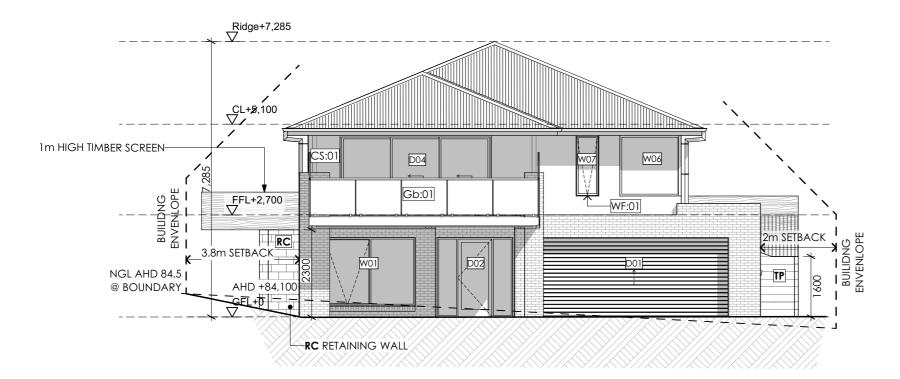

NORTH ELEVATION

@ A3 Scale1:100

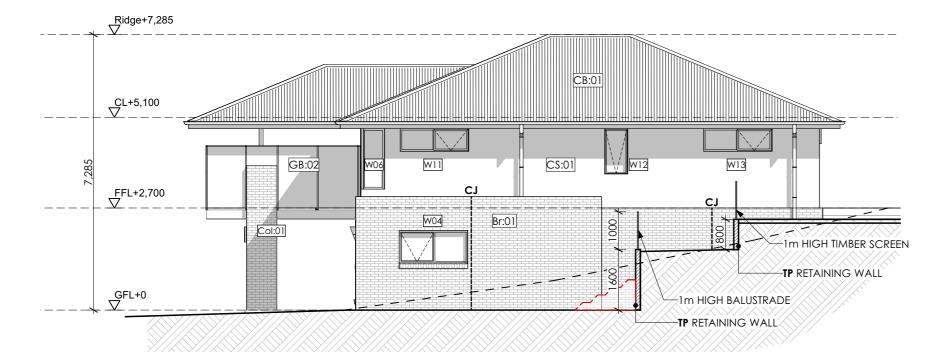

WEST ELEVATION

@ A3 Scale 1:100

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Rev ID Description Date

 PROJECT
 REVISION
 DATE

 CASSYTHA CLOSE
 13/11/2024

 4 VILLAGE DRIVE KINGSTON TAS 7050
 CLIENT
 PROJECT ID
 CHECKED BY

 MORNING STAR HOLDINGS PTY LTD
 2009
 A.HILL

LEGEND & NOTES

DP. Downpipe

FL. Floor level

CL. Ceiling level

Br:01 Face brickwork

CB:01 Colorbond roof

GB:01 Glass balustrade, min. 1,000mm high to comply with AS1288. 40dia. S/S handrail and verticals, supplied as a complete approved system with toughened glass and securely fixed to perimeter PFC. The complete system must be capable of bearing loading forces according to AS 1170.1

GB:02 Glass privacy screen min. 1,700mm high to comply with A\$1288. 40dia. S/\$ handrail and verticals, supplied as a complete approved system with toughened glass and securely fixed to perimeter PFC. The complete system must be capable of bearing loading forces according to A\$ 1170.1 No more than 25% transparency

WF:01 Powdercoated aluminium window / door frames

Colour: Basalt.

TD:01 Timber framed deck

CS:01 Easylap cement sheet

Conc:01 Concrete driveway

RW:01 190 series concrete block retaining wall

Col:01 rendered 100 series block column

TS:01 Timber screen

FC:01 Fibre cement sheet cladding Render finish

CJ Vertical articulation joints as shown or not more than 5m

FE 1m high timber screen

TP Treated pine retaining wall

SCALE

DRAWN BY

J. LIM

AS SHOWN @ A3

RC Reinforced concrete block retaining wall

--- NGL

FGI


Kingborough Council

Development Application: DA-2024-309
Plan Reference No: P2
Date Received: 13/11/2024


Date placed on Public Exhibition: 20/11/2024

PAGE	NORTH
L42-A105 LOT 42, 8 CASSYTHA CLOSE	
DRAWING	

Document Set ID: 4539586 Version: 1, Version Date: 18/11/2024

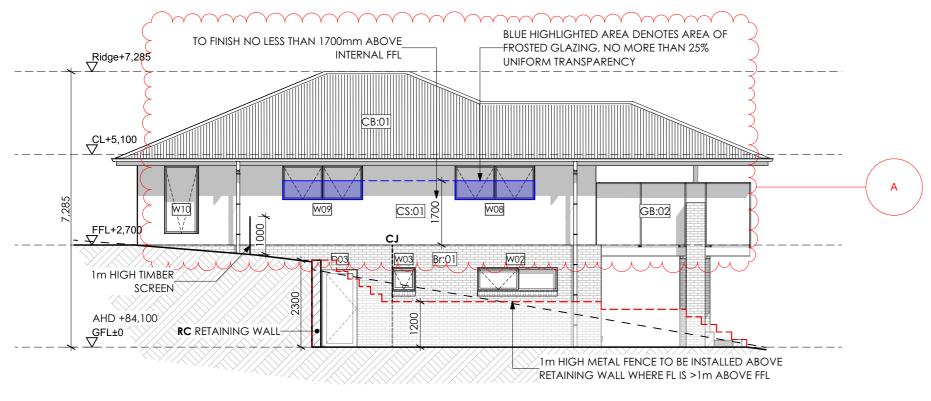

EAST ELEVATION @ A3 Scale1:100

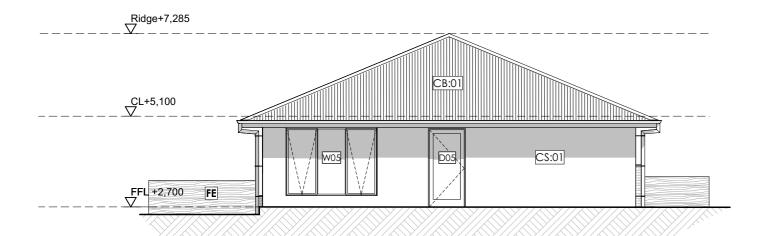

SOUTH ELEVATION E3 @ A3 Scale1:100

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Rev ID	Description	Date
A	WINDOW PRIVACY	13/11/2024
A	WINDOW PRIVACY	13/11/20

PROJECT	REVISION	DATE	SCALE
CASSYTHA CLOSE 4 VILLAGE DRIVE KINGSTON TAS 7050	A	13/11/2024	AS SHOWN @ A3
CLIENT	PROJECT ID	CHECKED BY	DRAWN BY
MORNING STAR HOLDINGS PTY LTD	2009	A.HILL	J. LIM

LEGEND & NOTES

DP. Downpipe

Floor level

CL. Ceiling level

FL.

Face brickwork Br:01

CB:01 Colorbond roof

Glass balustrade, min. 1,000mm high to comply with AS1288. 40dia. S/S handrail and verticals, supplied as a complete approved system with toughened glass and securely fixed to perimeter PFC. The complete system must be capable of bearing loading forces according to AS 1170.1

Glass privacy screen min. 1,700mm high to comply with AS1288. 40dia. S/S handrail and verticals, supplied as a complete approved system with toughened glass and securely fixed to perimeter PFC. The complete system must be capable of bearing loading forces according to AS 1170.1 No more than 25% transparency

Powdercoated aluminium window / door frames

Colour: Basalt.

TD:01 Timber framed deck

Easylap cement sheet

Conc:01 Concrete driveway

190 series concrete block retaining wall

Col:01 rendered 100 series block column

TS:01 Timber screen

Fibre cement sheet cladding Render finish FC:01

CJVertical articulation joints as shown or not more than

FE 1m high timber screen

Treated pine retaining wall

RC Reinforced concrete block retaining wall

NGL

Kingborough Council


Development Application: DA-2024-309


Plan Reference No: P2 Date Received: 13/11/2024

Date placed on Public Exhibition: 20/11/2024

1.40.4400	
L42-A106 LOT 42, 8 CASSYTHA CLOSE DRAWING	

Window Types

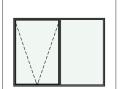

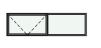























ID	W01
W x H Size	2,410×1,800
Sill Height	300
Opening Type	Awing
Glazing	Clear double gla
Frame type	Powdercoated Aluminium

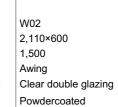



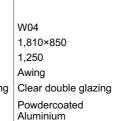

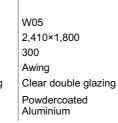

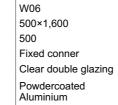


W06 1,500×1,600 500 Fixed conner Clear double glazing Powdercoated Aluminium

W07 600×1,600 500 Fixed conner Clear double glazing Powdercoated


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W10 300 Clear double glazing


900×1,800 Awing Clear double glazing Powdercoated Aluminium

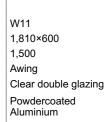



Window Types



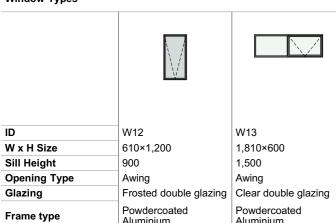


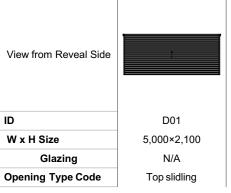

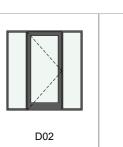


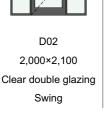


GENERAL NOTES

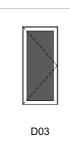



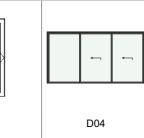

4,000×2,100 Clear double glazing Sliding

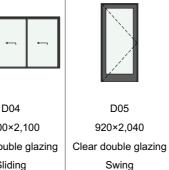

Kingborough Council

Development Application: DA-2024-309 Plan Reference No: P2 Date Received: 13/11/2024

Date placed on Public Exhibition: 20/11/2024

NOTE:

*BUILT AS APPROVED UNDER **DA-2021-215**



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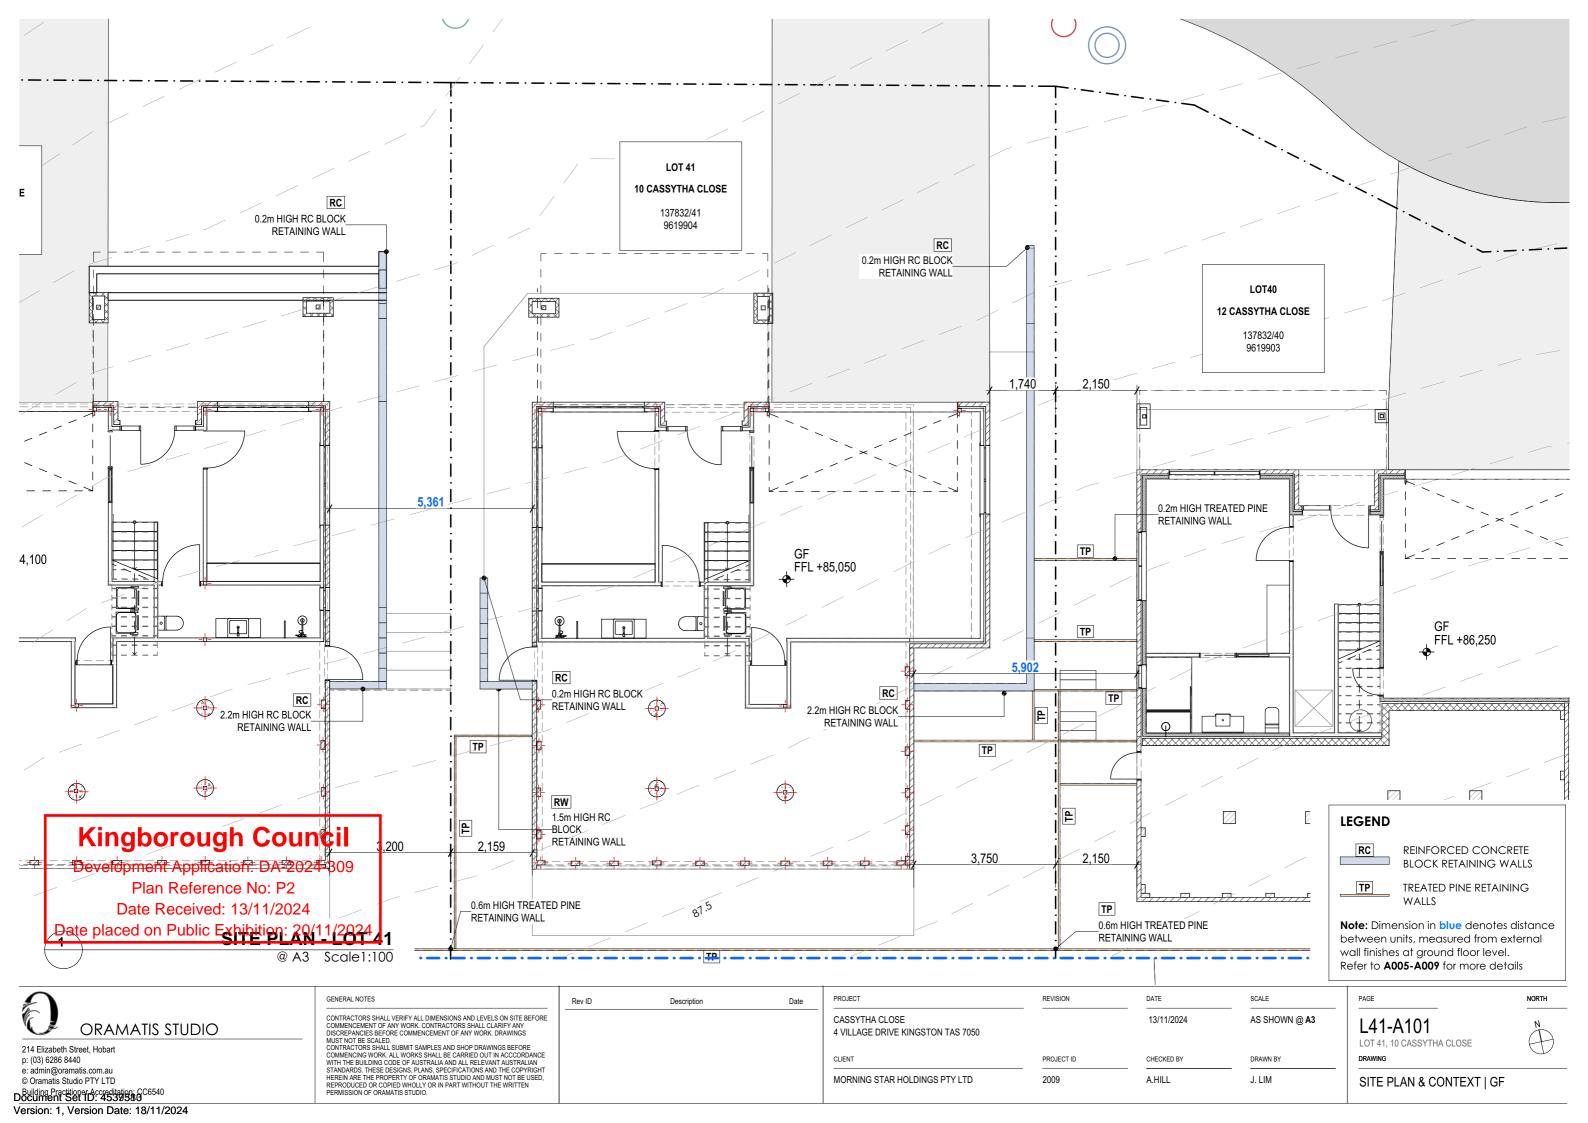
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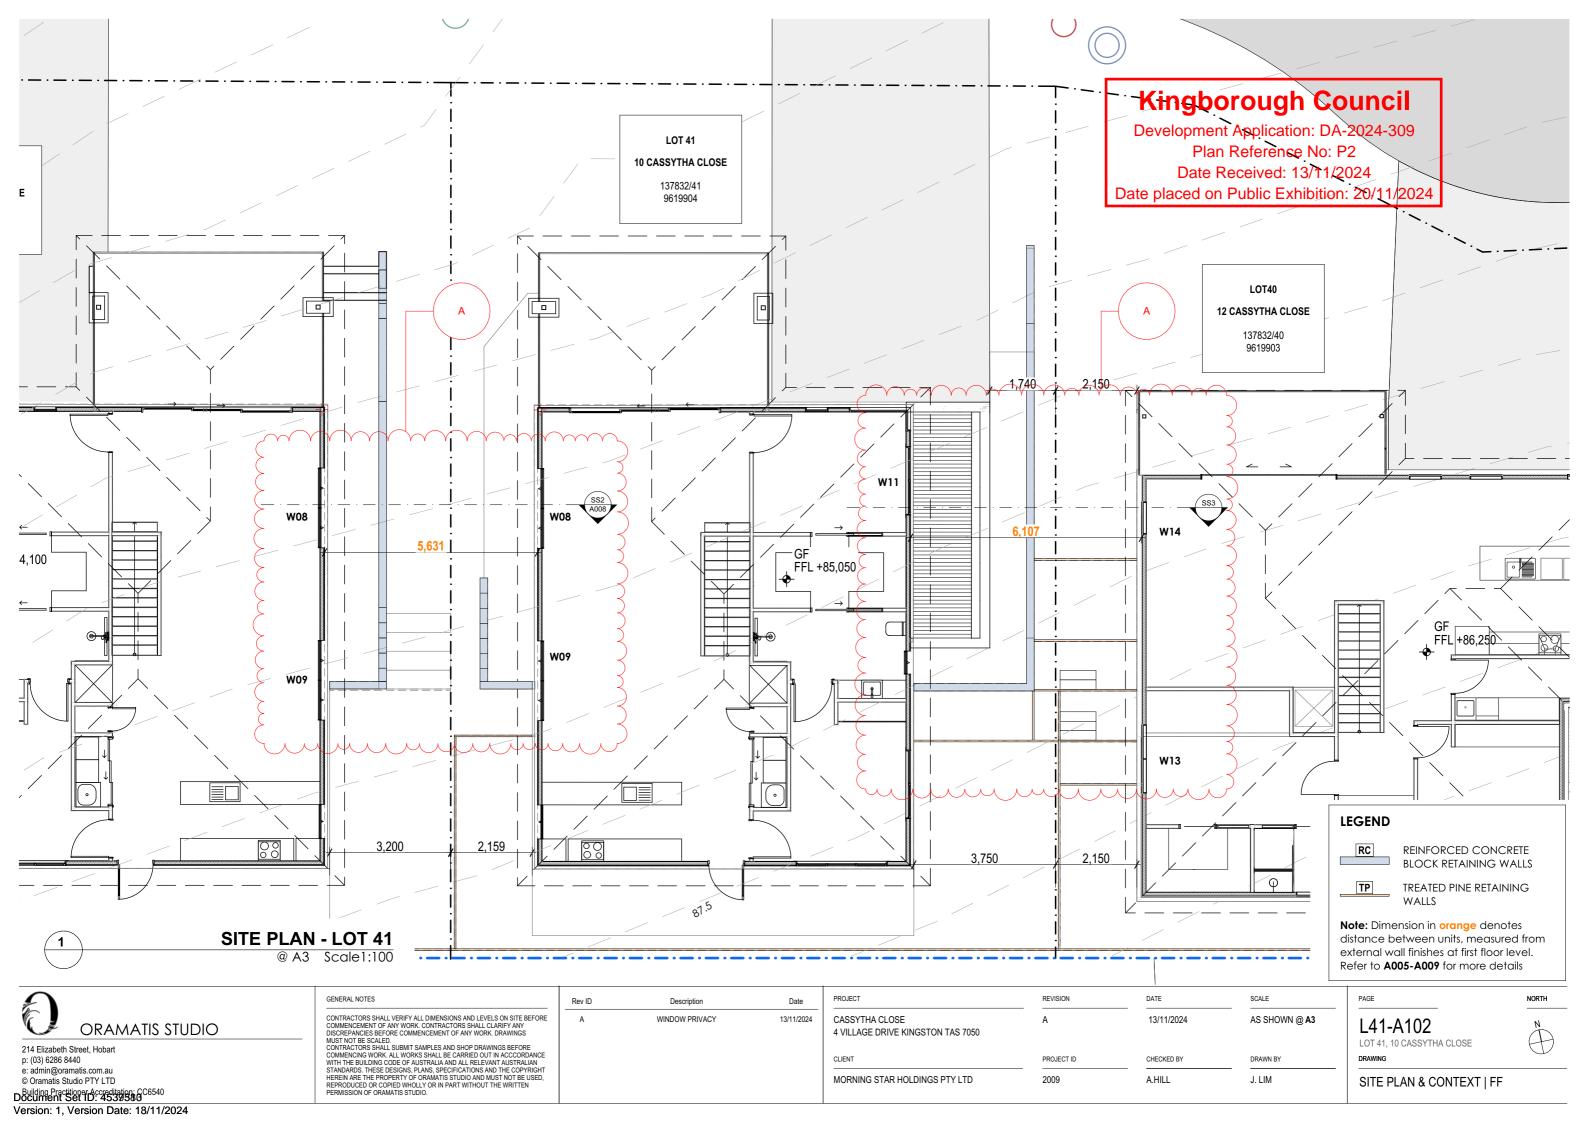
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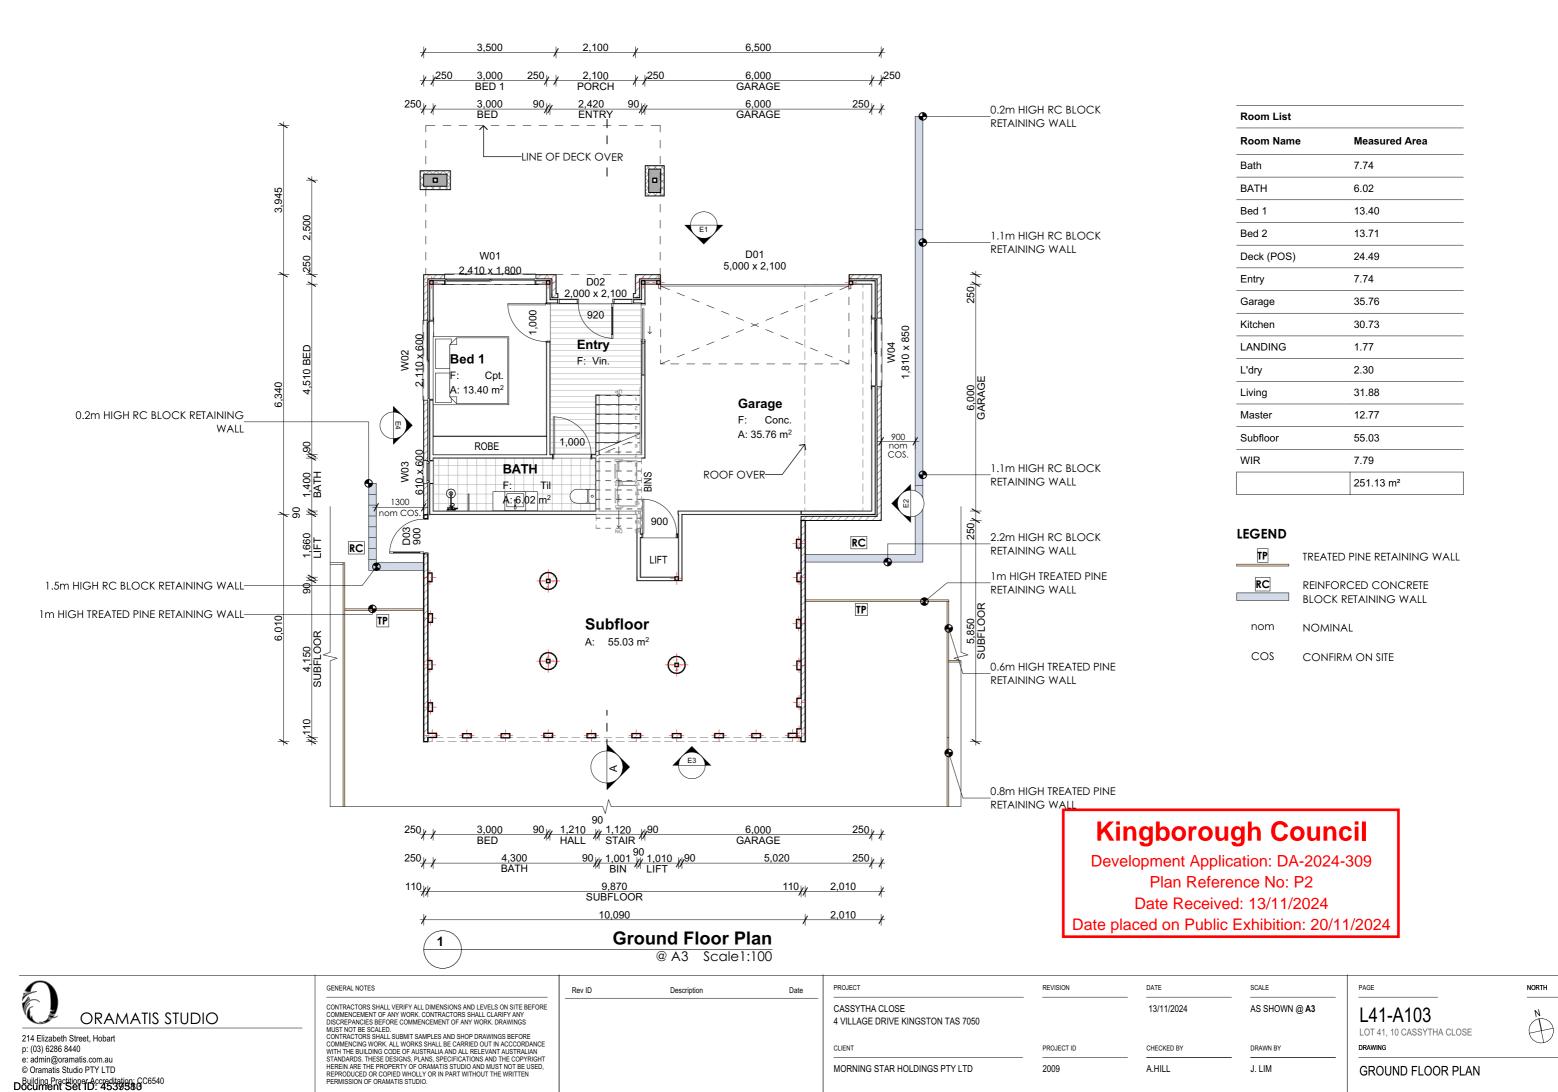
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	PROJECT	REVISION	DATE	SCALE
-	CASSYTHA CLOSE 4 VILLAGE DRIVE KINGSTON TAS 7050		13/11/2024	AS SHOWN @ A3
	CLIENT	PROJECT ID	CHECKED BY	DRAWN BY
	MORNING STAR HOLDINGS PTY LTD	2009	A.HILL	J. LIM

PAGE	NORTH
L42-A107 LOT 42, 8 CASSYTHA CLOSE	
DRAWING	







MORNING STAR HOLDINGS PTY LTD

2009


A.HILL


J. LIM

GROUND FLOOR PLAN

Document Set ID: 4539586 Version: 1, Version Date: 18/11/2024

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Kingborough Council

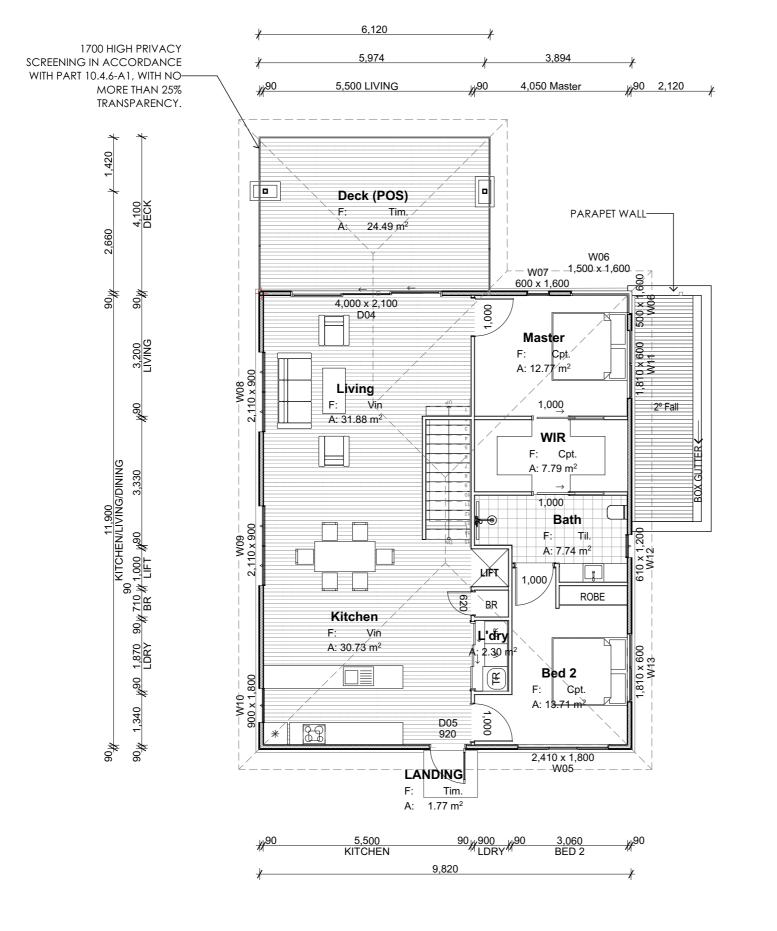Development Application: DA-2024-309 Plan Reference No: P2 Date Received: 13/11/2024

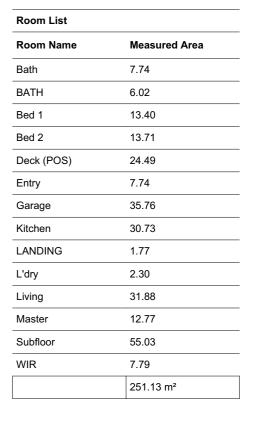Date placed on Public Exhibition: 20/11/2024

First Floor Plan @ A3 Scale1:100



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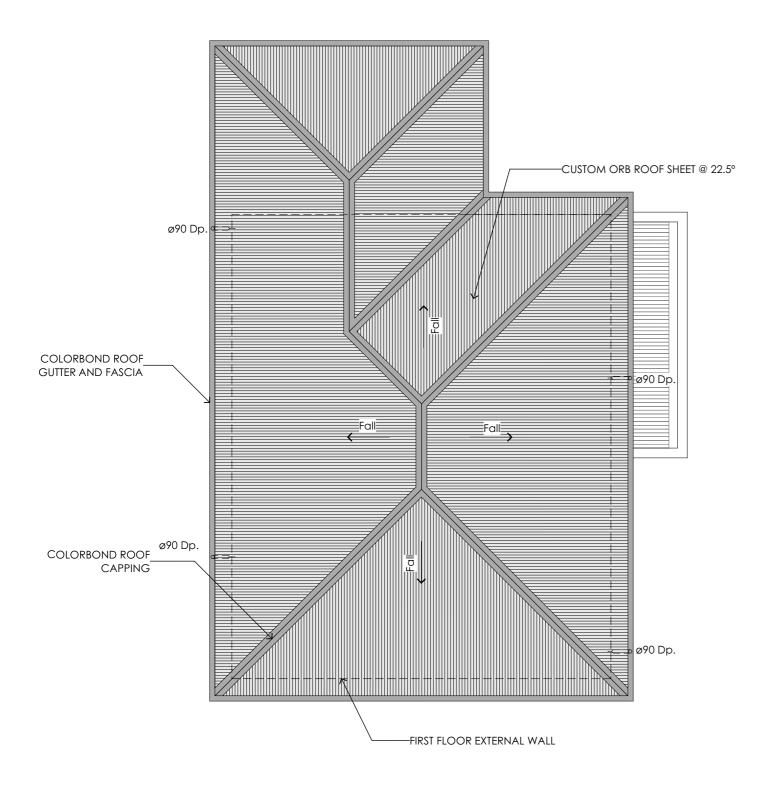
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PROJECT	REVISION	DATE	SCALE
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CLIENT	PROJECT ID	CHECKED BY	DRAWN BY
MORNING STAR HOLDINGS PTY LTD	2009	A.HILL	J. LIM

1,810 BATH

90,4490,

PAGE	NOF
L41-A104 LOT 41, 10 CASSYTHA CLOSE	
DRAWING	
FIRST FLOOR PLAN	





GENERAL NOTES



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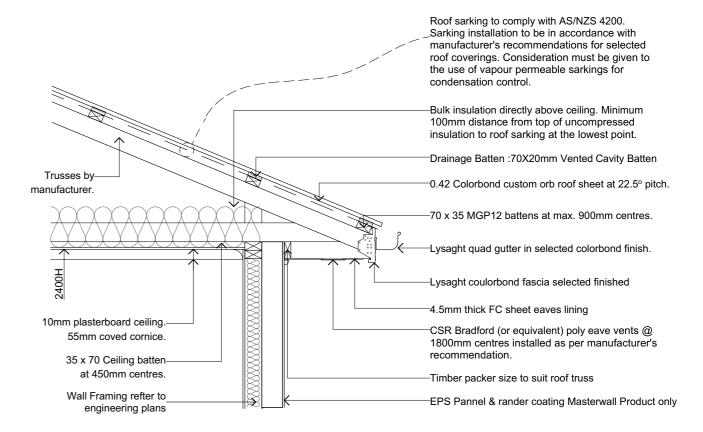
PROJECT REVISION DATE SCALE CASSYTHA CLOSE 13/11/2024 AS SHOWN @ A3 4 VILLAGE DRIVE KINGSTON TAS 7050 PROJECT ID CHECKED BY DRAWN BY MORNING STAR HOLDINGS PTY LTD 2009 A.HILL J. LIM

PAGE L41-A105 LOT 41, 10 CASSYTHA CLOSE DRAWING

LEGEND & NOTES

Downpipe 90dia PVC downpipe

1. GUTTERS MUST BE INSTALLED WITH A FALL OF NOT LESS THAN 1:500 FOR EAVES GUTTERS, UNLESS FIXED TO METAL FASCIAS; AND 1:100 FOR



ROOF CONDENSATION CONTROL DETAIL


Kingborough Council


Development Application: DA-2024-309 Plan Reference No: P2 Date Received: 13/11/2024

Date placed on Public Exhibition: 20/11/2024

ROOF PLAN

	AS3500.3 - S	STORMWATER DRAINAGE
_	2 (0.1)	405.04.0
Rc	Roof Catchment Area	195.81m2
	Roof Pitch	22.5 deg Rc x 1.21 slope factor = 236.93m2 (TABLE 3.2)
	Design Rainfall (100yr 5 min Duration)	116L/s (NCC Vol 2 Part 3.5.2.5)
	Downpipe Crossection	90dia - 6400 - (TABLE 3.3)
С	Max Catchment Area per Downpipe	64m2 (FIG 3.5 (A))
	Number Downpipes Required	Rp / C = 3.70
	Number Downpipes Provided	4 (rounded up)

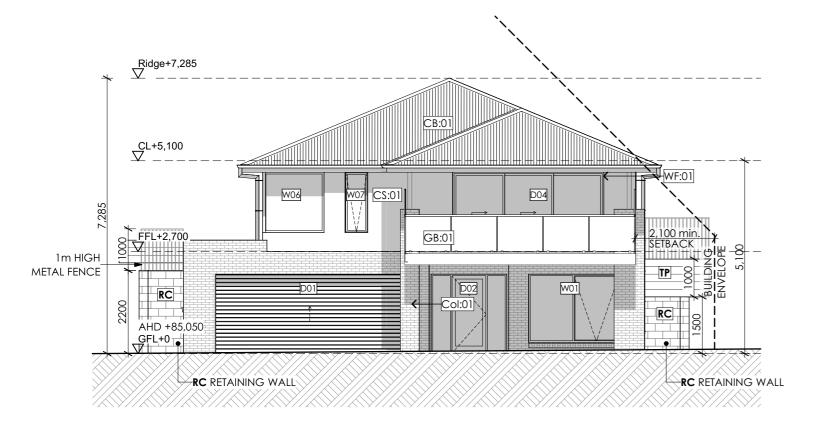

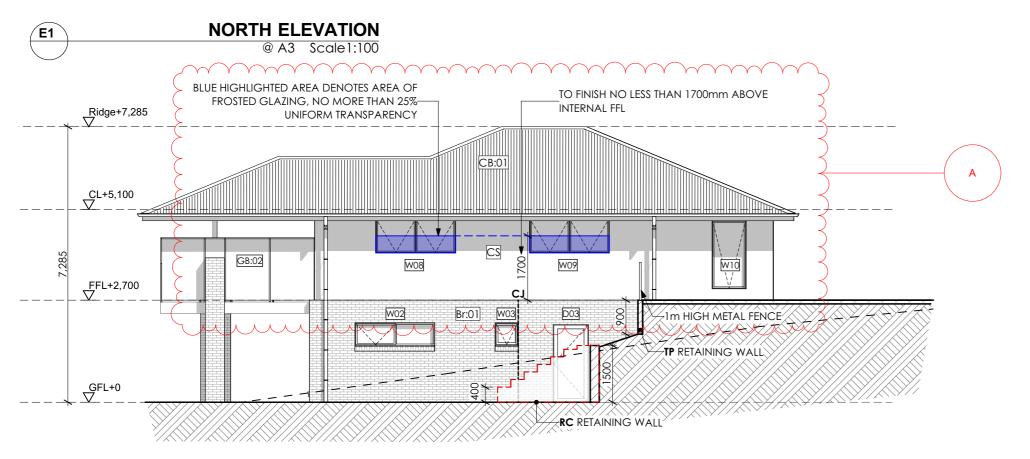

WEST ELEVATION **E4** @ A3 Scale1:100

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l	Rev ID	Description	Date
l	Α	WINDOW PRIVACY	13/11/2024
l			
l			
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PROJECT	REVISION	DATE	SCALE
CASSYTHA CLOSE 4 VILLAGE DRIVE KINGSTON TAS 7050	A	13/11/2024	AS SHOWN @ A3
CLIENT	PROJECT ID	CHECKED BY	DRAWN BY
MORNING STAR HOLDINGS PTY LTD	2009	Δ HII I	

LEGEND & NOTES

DP. Downpipe

FL. Floor level

CL. Ceiling level

Face brickwork Br:01

CB:01 Colorbond roof

Glass balustrade, min. 1,000mm high to comply with AS1288. 40dia. S/S handrail and verticals, supplied as a complete approved system with toughened glass and securely fixed to perimeter PFC. The complete system must be capable of bearing loading forces according to AS 1170.1

Glass privacy screen min. 1,700mm high to comply with AS1288. 40dia. S/S handrail and verticals, supplied as a complete approved system with toughened glass and securely fixed to perimeter PFC. The complete system must be capable of bearing loading forces according to AS 1170.1 No more than 25% transparency

Powdercoated aluminium window / door frames

Colour: Basalt.

TD:01 Timber framed deck

Easylap cement sheet

Conc:01 Concrete driveway

RW:01 190 series concrete block retaining wall

Col:01 rendered 100 series block column

TS:01 Timber screen

FC:01 Fibre cement sheet cladding Render finish

CJVertical articulation joints as shown or not more than 5m

FE 1m high timber screen

Treated pine retaining wall

RC Reinforced concrete block retaining wall


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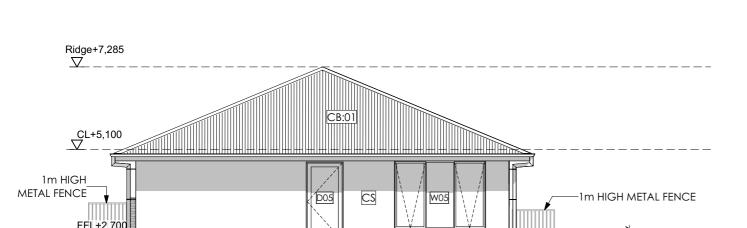
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Development Application: DA-2024-309 Plan Reference No: P2 Date Received: 13/11/2024

Date placed on Public Exhibition: 20/11/2024

PAGE NORTH L41-A106 LOT 41, 10 CASSYTHA CLOSE **ELEVATION 01**



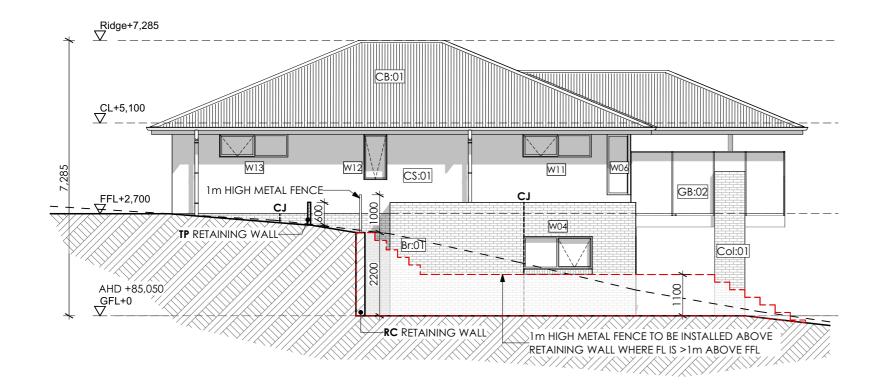

EAST ELEVATION

@ A3 Scale1:100

SOUTH ELEVATION @ A3 Scale1:100

Kingborough Council

Development Application: DA-2024-309 Plan Reference No: P2 Date Received: 13/11/2024 Date placed on Public Exhibition: 20/11/2024

LEGEND & NOTES

DP. Downpipe FL. Floor level CL. Ceiling level Face brickwork Br:01 CB:01 Colorbond roof Glass balustrade, min. 1,000mm high to comply with AS1288. 40dia. S/S handrail and verticals, supplied as a complete approved system with toughened glass and securely fixed to perimeter PFC. The complete system must be capable of bearing loading forces according to AS 1170.1 Glass privacy screen min. 1,700mm high to comply with AS1288. 40dia. S/S handrail and verticals, supplied as a complete approved system with toughened glass and securely fixed to perimeter PFC. The complete system must be capable of bearing loading forces according to AS 1170.1 No more than 25% transparency Powdercoated aluminium window / door frames Colour: Basalt. TD:01 Timber framed deck

Easylap cement sheet

Conc:01 Concrete driveway

190 series concrete block retaining wall

Col:01 rendered 100 series block column

TS:01 Timber screen

Fibre cement sheet cladding Render finish FC:01

CJVertical articulation joints as shown or not more than

FE 1m high timber screen

Treated pine retaining wall

RC Reinforced concrete block retaining wall

NGL

FGL

•	

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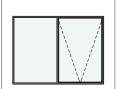
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CLIENT	PROJECT ID	CHECKED BY	DRAWN BY
MORNING STAR HOLDINGS PTY LTD	2009	A.HILL	J. LIM

PAGE	NORTH
L41-A107 LOT 41, 10 CASSYTHA CLOSE DRAWING	
ELEVATION 02	

Window Types


























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N x H Size	2,410×1,800
Sill Height	300
Opening Type	Awing
Glazing	Clear double gla
rame type	Powdercoated Aluminium

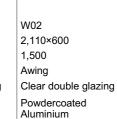


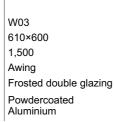

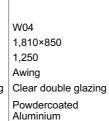

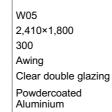

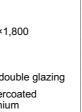

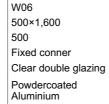


W06 1,500×1,600 500 Fixed conner Clear double glazing Powdercoated Aluminium

W07 600×1,600 500 Fixed conner Clear double glazing Powdercoated Aluminium


W08 2.110×900 1,250 Awing Aluminium

W09 2.110×900 1,250 Awing Clear double glazing Clear double glazing Powdercoated Powdercoated Aluminium


W10 900×1,800 300 Awing Clear double glazing Powdercoated Aluminium

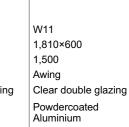


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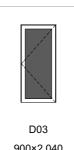


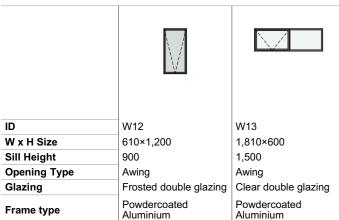




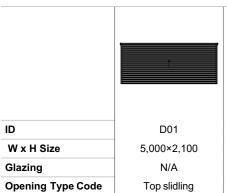





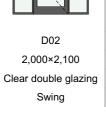



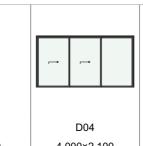

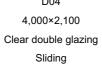

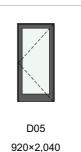

Clear double glazing

Kingborough Council

Development Application: DA-2024-309 Plan Reference No: P2 Date Received: 13/11/2024

Date placed on Public Exhibition: 20/11/2024

NOTE:

*BUILT AS APPROVED UNDER DA-2021-214



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CLIENT	PROJECT ID
CASSYTHA CLOSE 4 VILLAGE DRIVE KINGSTON TAS 7050	
PROJECT	REVISION

SCALE	PAGE
AS SHOWN @ A3	L41-A108 LOT 41, 10 CASSYTHA CLOSE
DRAWN BY	DRAWING
J. LIM	WINDOW & DOOR SCHEDULE


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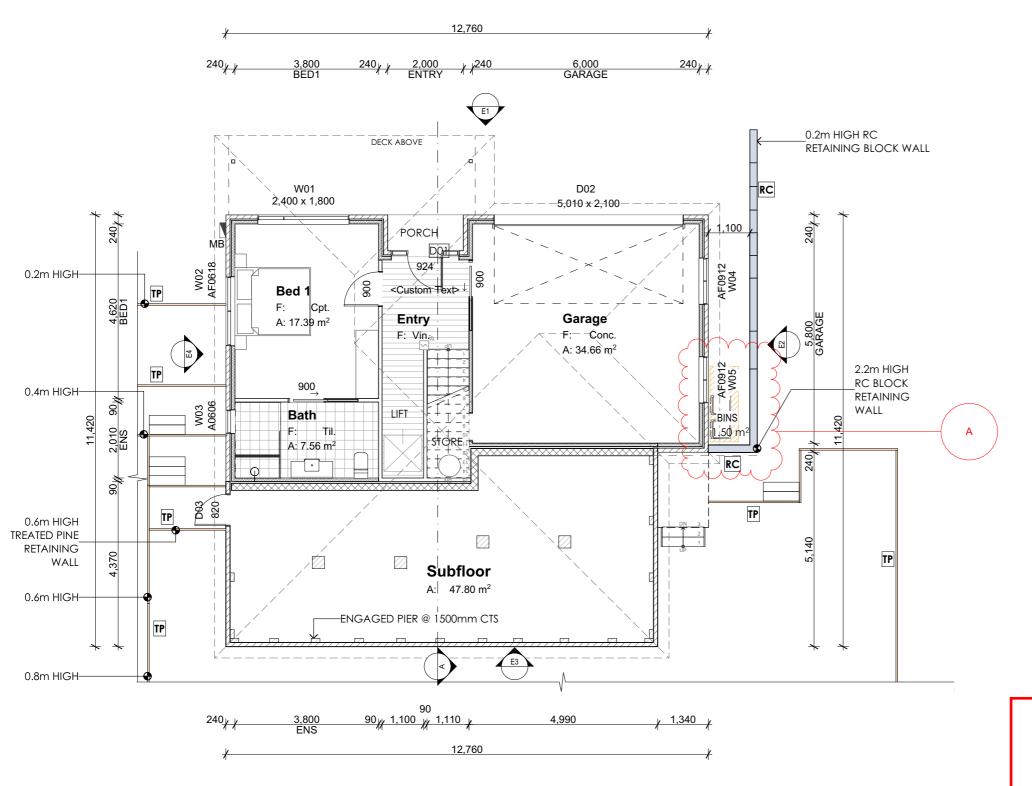
13/11/2024

CHECKED BY

A.HILL

PAGE	N .
L41-A108 LOT 41, 10 CASSYTHA CLOSE	
DRAWING	



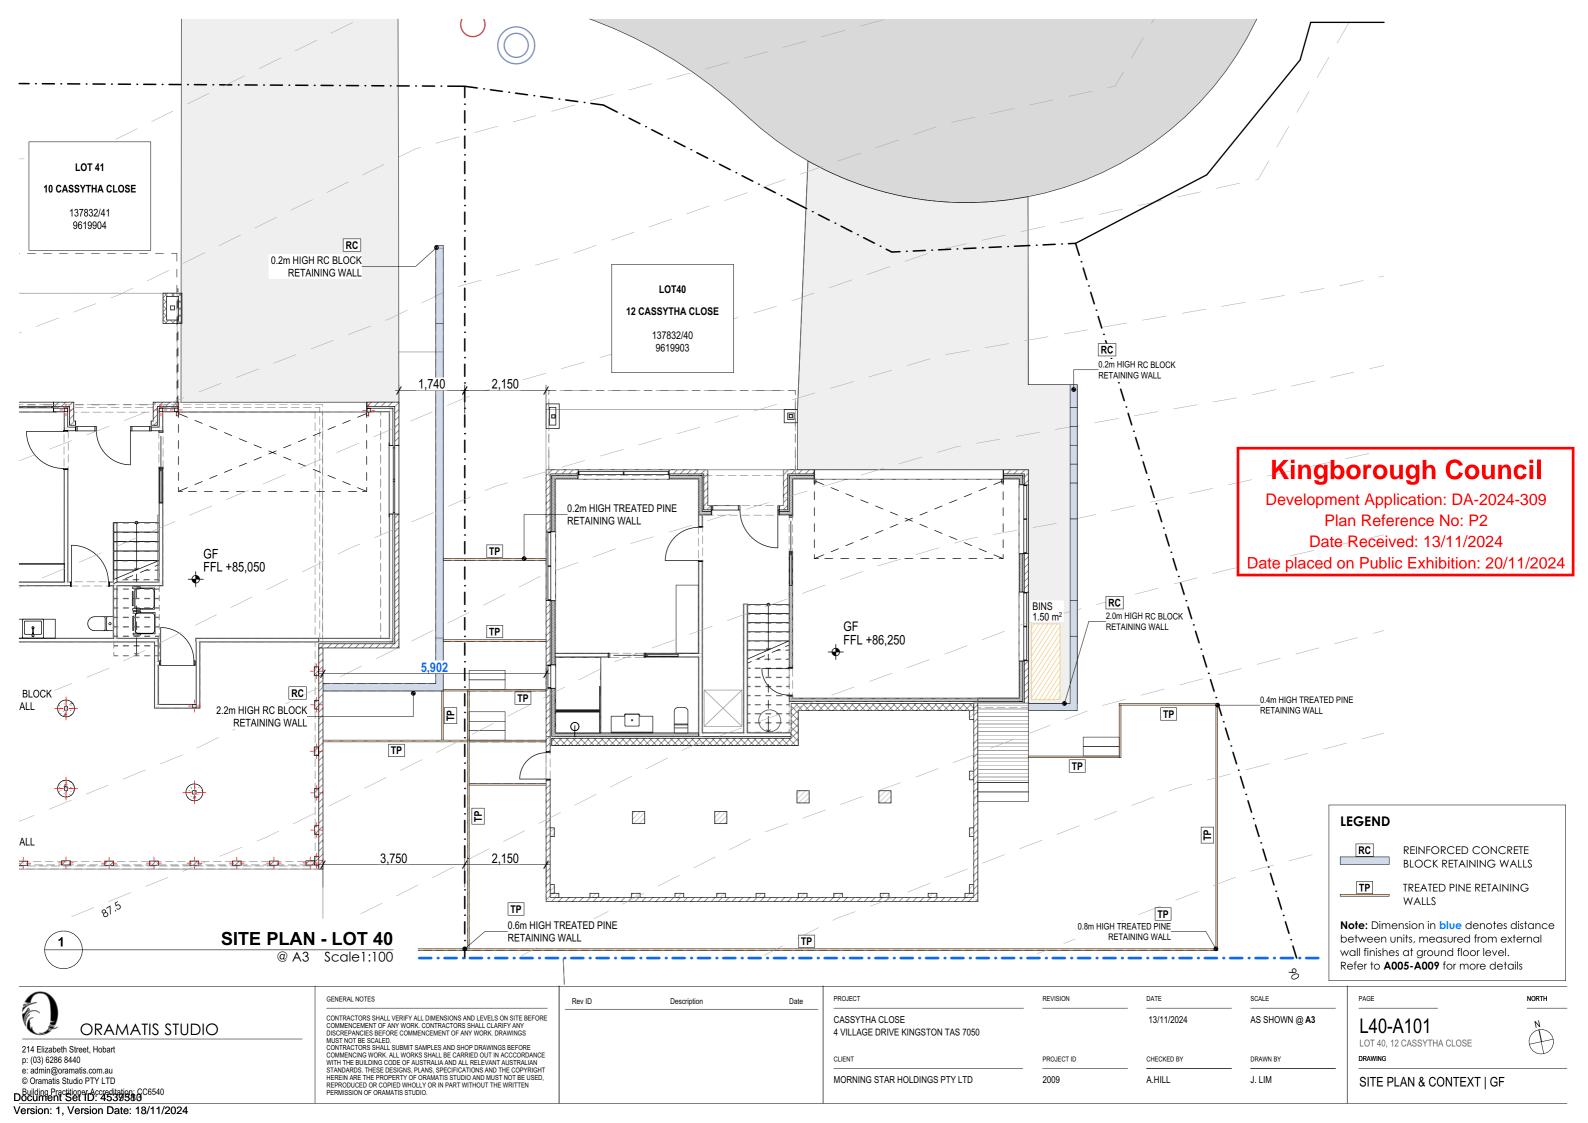

Room List		
Room Name	Measured Area	
Bath	7.56	
Bed 1	33.49	
Bed 2	16.50	
Deck	14.68	
Dining	12.46	
Ens.	7.07	
Entry	13.67	
Garage	34.66	
Hall	8.22	
Kitchen	19.49	
L'dry	5.86	
Living	27.39	
Subfloor	47.80	
WIR	4.62	
	253.47 m²	

LEGEND

TP

TREATED PINE RETAINING WALL

REINFORCED CONCRETE **BLOCK RETAINING WALL**

nom NOMINAL

CONFIRM ON SITE

Kingborough Council

Development Application: DA-2024-309 Plan Reference No: P2 Date Received: 13/11/2024

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Ground Floor Plan

@ A3 Scale1:100



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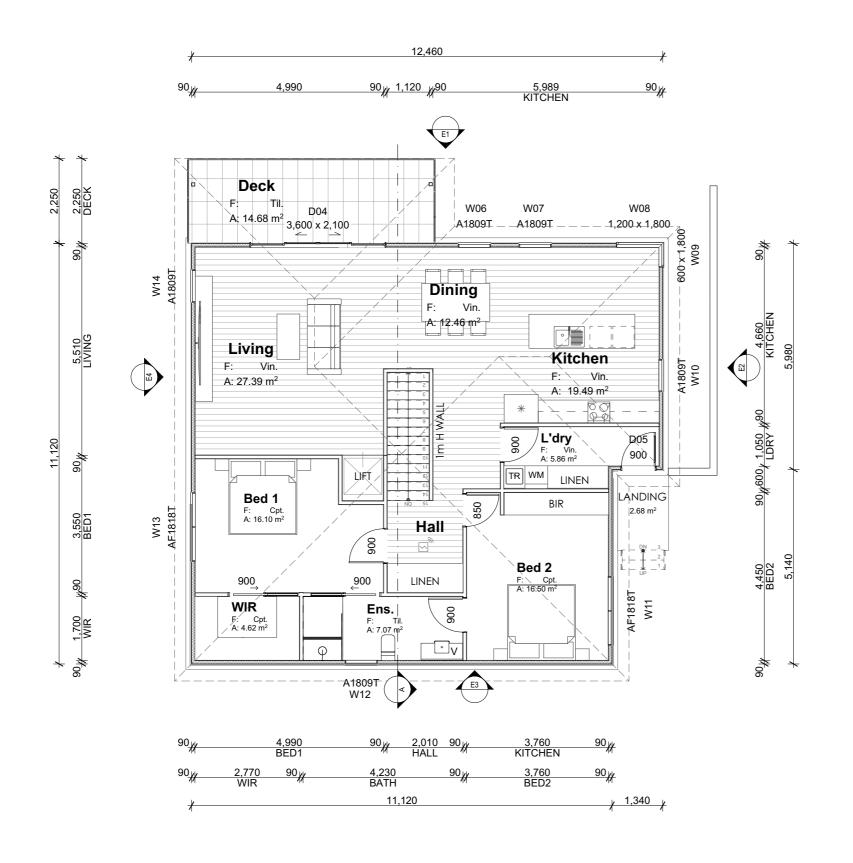
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MORNING STAR HOLDINGS PTY LTD	2009	A.HILL	J. LIM





Room List		
Room Name	Measured Area	
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Living	27.39	
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WIR	4.62	
	253.47 m²	

LEGEND

TP

TREATED PINE RETAINING WALL



REINFORCED CONCRETE BLOCK RETAINING WALL

nom

NOMINAL

CONFIRM ON SITE

Kingborough Council

Development Application: DA-2024-309 Plan Reference No: P2

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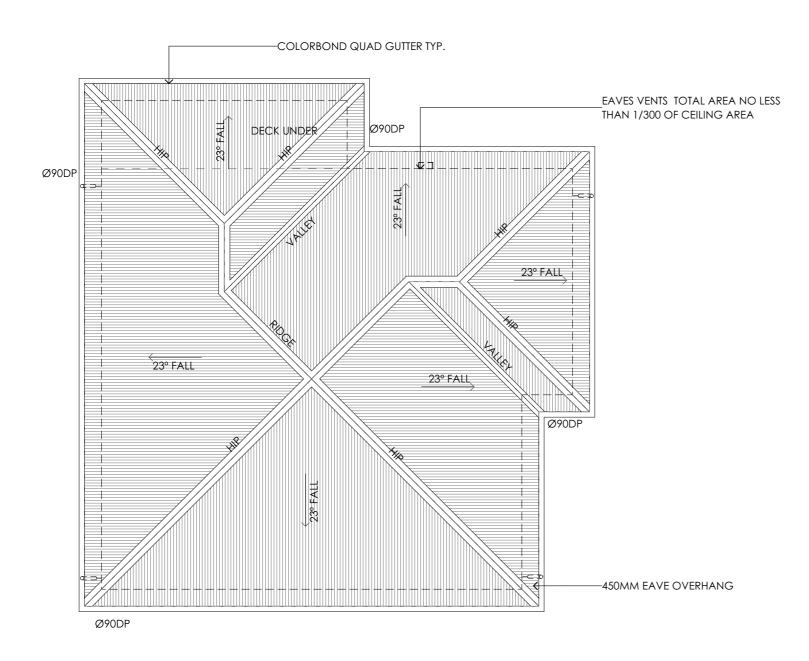
Rev ID	Description	Date

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FIRST FLOOR PLAN

Document Set ID: 4539586 Version: 1, Version Date: 18/11/2024



Development Application: DA-2024-309 Plan Reference No: P2 Date Received: 13/11/2024

Kingborough Council

Date placed on Public Exhibition: 20/11/2024

Roof Plan

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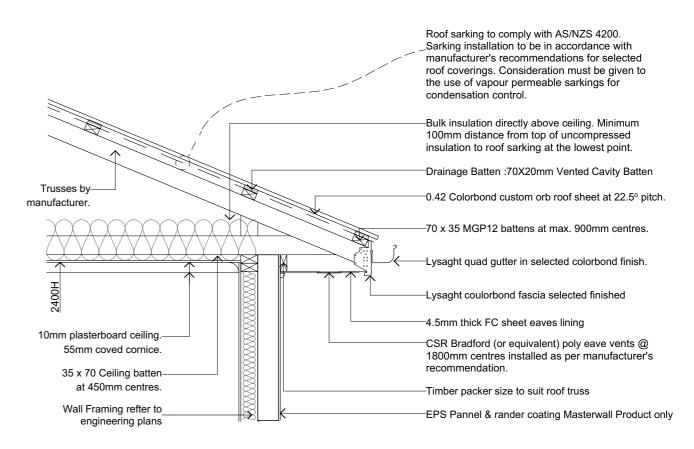
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CLIENT	PROJECT ID	CHECKED BY	DRAWN BY
MORNING STAR HOLDINGS PTY LTD	2009	A.HILL	J. LIM

LEGEND & NOTES Downpipe 90dia PVC downpipe

1. GUTTERS MUST BE INSTALLED WITH A FALL OF NOT LESS THAN 1:500 FOR EAVES GUTTERS, UNLESS FIXED TO METAL FASCIAS; AND 1:100 FOR




ROOF CONDENSATION CONTROL DETAIL

	AS3500.3 - S	STORMWATER DRAINAGE
Rc	Roof Catchment Area	195.81m2
	Roof Pitch	22.5 deg Rc x 1.21 slope factor = 236.93m2 (TABLE 3.2)
	Design Rainfall (100yr 5 min Duration)	116L/s (NCC Vol 2 Part 3.5.2.5)
	Downpipe Crossection	90dia - 6400 - (TABLE 3.3)
С	Max Catchment Area per Downpipe	64m2 (FIG 3.5 (A))
	Number Downpipes Required	Rp / C = 3.70
	Number Downpipes Provided	4 (rounded up)





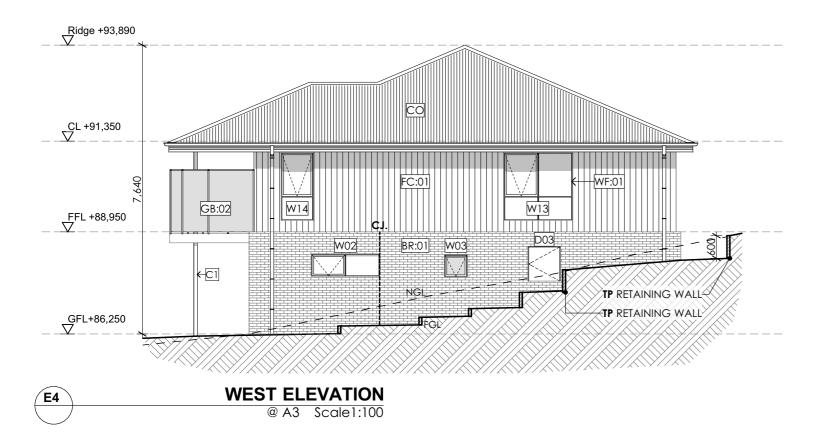

LEGEND & NOTES

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CL.	Ceiling level
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CB:01	Colorbond roof
GB:01	Glass balustrade, min. 1,000mm high to comply with AS1288. 40dia. S/S handrail and verticals, supplied a complete approved system with toughened glass and securely fixed to perimeter PFC. The complete system must be capable of bearing loading forces according to AS 1170.1
GB:02	Glass privacy screen min. 1,700mm high to comply with AS1288. 40dia. S/S handrail and verticals, supplied as a complete approved system with toughened glass and securely fixed to perimeter PFC. The complete system must be capable of bearing loading forces according to AS 1170.1 No more than 25% transparency
WF:01	Powdercoated aluminium window / door frames Colour: Basalt.
TD:01	Timber framed deck
CS:01	Easylap cement sheet
Conc:01	Concrete driveway
RW:01	190 series concrete block retaining wall
Col:01	rendered 100 series block column
TS:01	Timber screen

Treated pine retaining wall

FE 1m high timber screen

RC Reinforced concrete block retaining wall

Fibre cement sheet cladding Render finish

Vertical articulation joints as shown or not more than

--- NGL

CJ

Kingborough Council

Development Application: DA-2024-309 Plan Reference No: P2

Date Received: 13/11/2024

Date placed on Public Exhibition: 20/11/2024



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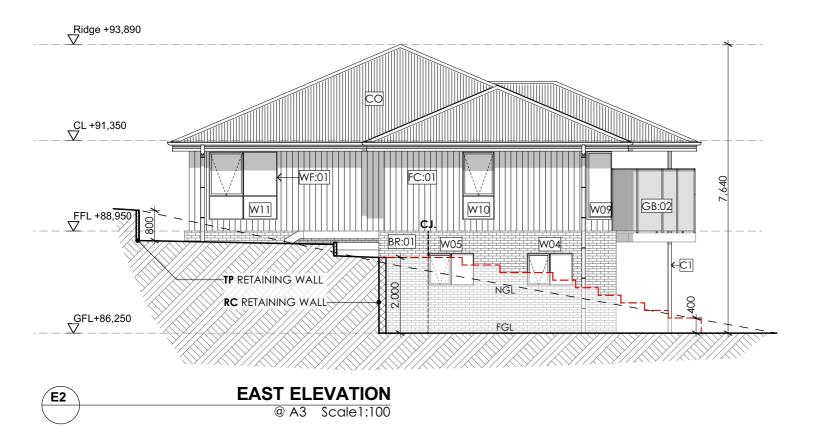
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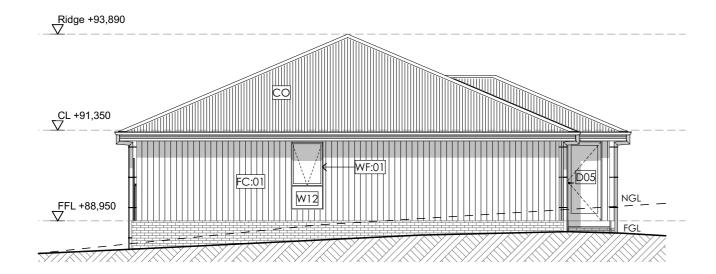
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Description

PROJECT	REVISION	DATE	SCALE
CASSYTHA CLOSE 4 VILLAGE DRIVE KINGSTON TAS 7050		13/11/2024	AS SHOWN @ A3
CLIENT	PROJECT ID	CHECKED BY	DRAWN BY
MORNING STAR HOLDINGS PTY LTD	2009	A.HILL	J. LIM

PAGE	NORTH
L40-A105 LOT 40, 12 CASSYTHA CLOSE	
DRAWING	





SOUTH ELEVATION @ A3 Scale1:100

E3

Version: 1, Version Date: 18/11/2024

Development Application: DA-2024-309 Plan Reference No: P2

LEGEND & NOTES

DP.	Downpipe
FL.	Floor level
CL.	Ceiling level
Br:01	Face brickwork
CB:01	Colorbond roof
GB:01	Glass balustrade, min. 1,000mm high to comply with A\$1288. 40dia. S/S handrail and verticals, supplied as a complete approved system with toughened glass and securely fixed to perimeter PFC. The complete system must be capable of bearing loading forces according to A\$ 1170.1
GB:02	Glass privacy screen min. 1,700mm high to comply with A\$1288. 40dia. \$/\$ handrail and verticals, supplied as a complete approved system with toughened glass and securely fixed to perimeter PFC. The complete system must be capable of bearing loading forces according to A\$ 1170.1 No more than 25% transparency
WF:01	Powdercoated aluminium window / door frames Colour: Basalt.
TD:01	Timber framed deck
CS:01	Easylap cement sheet
Conc:0	1 Concrete driveway
RW:01	190 series concrete block retaining wall
Col:01	rendered 100 series block column
TS:01	Timber screen
FC:01	Fibre cement sheet cladding Render finish
Cl	Vertical articulation joints as shown or not more than 5m
	FE 1m high timber screen
	TP Treated pine retaining wall


RC Reinforced concrete block retaining wall

NGL FGL

King	boroug	h Council	
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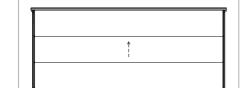
Date Received: 13/11/2024 Date placed on Public Exhibition: 20/11/2024

$\overline{\mathcal{O}}$	GENERAL NOTES	Rev ID	Description	Date	PROJECT	REVISION	DATE	SCALE	PAGE	NORTH
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214 Elizabeth Street, Hobart p: (03) 6286 8440	COMMENCING WORK. ALL WORKS SHALL BE CARRIED OUT IN ACCCORDANCE WITH THE BUILDING CODE OF AUSTRALIA AND ALL RELEVANT AUSTRALIAN				CLIENT	PROJECT ID	CHECKED BY	DRAWN BY	DRAWING	
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ID D01 W x H Size 900×2,060 Sill Height 0 Opening Type Swina Glazing Frosted Double Glazing Frame Type Powdercoated Aluminium

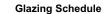


D02 5,010×2,100 0 Roller N/A

Powdercoated Aluminium



D03 D04 3,600×2,100 820×900 1,400 0 Slidina Swing Clear Double Glazing Clear Double Glazing Powdercoated Aluminium Powdercoated Aluminium

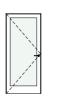

Powdercoated Aluminium

D05 W01 900×2,100 2,400×1,800 0 300 Fixed/Awning Swina Clear Double Glazing Clear Double Glazing



W02 1,810×600 1,520 Fixed/Awning Clear Double Glazing Powdercoated Aluminium



W03 W04 610×600 1,500 1,260 Fixed/Awning Frosted Double Glazing Powdercoated Aluminium



1,210×860 Fixed/Awning Clear Double Glazing Powdercoated Aluminium

Glazing Schedule



ID W05 W x H Size 1,210×860 Sill Height 1,260 **Opening Type** Fixed/Awning Glazing Clear Double Glazing Frame Type Powdercoated Aluminium



W06 850×1,800 300 Fixed/Awning Clear Double Glazing Powdercoated Aluminium



W07 850×1,800 300 Fixed/Awning Clear Double Glazing Powdercoated Aluminium



W08 1,200×1,800 300 Fixed Clear Double Glazing Powdercoated Aluminium



W09 600×1,800 300 Fixed Clear Double Glazing Powdercoated Aluminium



W10 W11 850×1,800 1,810×1,800 300 300 Fixed/Awning Fixed/Awning Clear Double Glazing Clear Double Glazing Powdercoated Aluminium Powdercoated Aluminium

Powdercoated Aluminium



W12 850×1,800 300 Fixed/Awning Clear Double Glazing Powdercoated Aluminium



W13 1,810×1,800 300 Fixed/Awning Frosted Double Glazing Powdercoated Aluminium

Glazing Schedule



Kingborough Council

Development Application: DA-2024-309 Plan Reference No: P2 Date Received: 13/11/2024

Date placed on Public Exhibition: 20/11/2024



ORAMATIS STUDIO

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Description

PROJECT REVISION DATE SCALE CASSYTHA CLOSE 13/11/2024 AS SHOWN @ A3 4 VILLAGE DRIVE KINGSTON TAS 7050 PROJECT ID CHECKED BY DRAWN BY A.HILL MORNING STAR HOLDINGS PTY LTD 2009 J. LIM

PAGE	NORTH
L40-A107 LOT 40, 12 CASSYTHA CLOSE	
DRAWING	